

# Factsheet Auto Shredder Residue (ASR) Repository Shepherd, MT October 31, 2023

### **Key Project Points of Interest**

- The repository is for the company's non-hazardous ASR only. It will not be a public landfill.
- The repository footprint will be less than 24 acres over the next 25 years. After an area is completed, it will be prepared for use as a grazing site.
- The project will be compliant with all federal, state, and local regulations.

### **About Pacific Steel & Recycling**

PS&R Pacific Steel and Recycling has been in Montana for more than 100 years and is headquartered in Great Falls, MT. The company and its employee owners are dedicated to steel and recycling service needs.

Each year, more than 130 million metric tons of scrap metal, paper, plastic, glass, textiles, rubber, and electronics are manufactured into various grades of repurposed steel with the support of the scrap recycling and shredding industry. Without this, the unwanted items would be discarded. Recycling saves energy, natural resources and reduces greenhouse emissions.

Pacific Steel and Recycling owns and operates one of nearly 300 auto shredder facilities in the United States. (See photo.) At its facility outside of Billings, the company recovers almost 80 percent of the material generated while shredding items like appliances and automobiles. The portion of non-recoverable materials is referred to as auto shredding residue (ASR), which consists of fine metallics, plastics and glass, sorted-out during the recycling process.

### The Purpose of Project Forward

Project Forward is dedicated to developing and licensing a monofill repository facility to store ASR. This allows for the possibility of maximum recovery of recyclable material in the future – instead of forever disposal in a landfill. New technology shows industry may be within a few years of such opportunity. At this time, the material is sent to the Billings Regional Landfill and can never be reclaimed.

### **Questions and Answers about the Project**

### The Material

### What do the letters ASR mean?

The portion of non-recoverable materials collected during the shredding process is referred to as auto shredding residue (ASR).

### What is ASR?

It consists of fine metallics, plastics and glass, sorted-out during the recycling process.

### Is the material hazardous?

It is not. It is classified by the state of Montana as non-hazardous. It is in the same classification as residential waste.

### How do you know it is non-hazardous?

There is quarterly testing by a qualified third-party that is used to ensure the material is meeting that classification. This material has been going to the Billings Regional Landfill since 2014.

### Is this facility accepting all material allowed in with a Class II license?

A Class II permit covers various material as described in the MDEQ Environmental Assessment. Pacific has committed to only placing ASR in the repository. That is detailed in the application and will be bound by law.

### **Site Selection and Purpose**

### Why does Pacific Steel and Recycling want to build a repository?

Technology is advancing. The respository allows for maximum recovery of recyclable material (i.e., environmental sustainability) instead of forever disposal in a landfill. It enables the company to have complete oversight of the process and immediate access to the material.

### Why build a repository?

Recycling is about keeping things out of a landfill. This allows for the possibility of maximum recovery of recycled material in the future - instead of forever disposal in a landfill. New technology shows industry may be within a few years of such opportunity.

### Why was the site selected?

The site was selected due to its proximity with Pacific's recycling facilities. The site's geology meets the requirements for constructing a repository.

### What environmental studies were used to prepare the plans?

The application includes several years of site research and planning to determine the viability of the project. Before the repository design work began, the team at Montana-based Great West Engineering carried out on-site testing to define the appropriate specifications for the project. This included site borings to know the exact characteristics of the soil and rock formations at various levels below the surface. Additionally, drilling was conducted in various areas of the site to learn the depth at which moisture and/or water could be detected. Details from the borings and drilling were used to complete the application for the facility and includes measures to ensure groundwater protection. Additional studies were carried out to define overall protective measures for the project. This includes traffic and road safety, daily operations of the facility, methods to manage aesthetics and surface water that comes onto the site.

### Who conducted the studies?

This work was conducted by Montana-based Great West Engineering. Led by a team of experts in this field, Great West has more than 35 years of experience in designing and constructing facilities, such as Project Forward.

### What agencies were involved in the project?

Montana DEQ is the primary agency involved. DEQ included multiple agencies and special interest groups in its license review and environmental assessment process.

### How was the facility designed?

The facility will be lined with a state of-the-art composite liner system and leachate collection system to prevent contamination to groundwater. It will be equipped with a groundwater monitoring network which will be regularly tested to ensure groundwater is not contaminated. Also, it will meet all federal, state, and local stormwater control requirements including no discharge 25 year, 24 hour, storm event criteria.

### **Application and Environmental Assessment**

### Who prepared the application?

It was prepared by Great West Engineering on behalf of Pacific Steel and Recycling.

### Who prepared the draft environmental assessment?

The Montana Department of Environmental Quality.

### How is the comment period decided?

MT DEQ determined ten days (initial). The agency has added an extension through the end of November.

### **Operations**

### What are the hours of operation?

The site routine will operate 8 a.m. until 5 p.m., Monday through Friday.

### How many people will work at the site?

It is anticipated that two people will work at the site.

### What type of equipment will be used?

For the small scale project, the facility will have three equipment on-site: a loader, a compactor and an excavator.

### What will this look like aesthetically? Will you develop landscaping to blend into the local landscape?

The facility will be constructed and maintained aesthetically to blend in with the local landscape.

### What is the process for placing the material in the storage area?

A trailer will unload material to the ground, a compactor will spread and compact material into the repository, and a loader will provide daily cover.

### How long does it take to unload one truck and properly store the material?

The three step process will take less than one hour for each load.

### How will you prevent dust from leaving the site?

Pacific Steel & Recycling has committed to controlling dust on site by watering on-site roads and applying dust suppression on Shepherd Acton Road between the highway and Pacific's approach to the facility.

### Will you stop operations during windy periods?

Pacific Steel and Recycling has committed to stopping operations during high-wind events.

### What level and type of sound will come from the site?

It will be a muffled diesel engine when the compactor is operating, and an idling or backup indicator when the hauler is at the site. The facility will be open 8 a.m. to 5 p.m., Monday thru Friday. During the construction period, which is anticipated to be approximately 90 days, more equipment will be on the site during daylight hours.

### How much lighting will there be at the site at night?

The only lighting will be a security light for the building.

### Transportation

### How will be the material be transported to the site?

It will be hauled by truck.

### What will be the transportation route?

It will be hauled on Highway 87 to Shepherd Acton Road.

### How will trucks enter and exit the site?

Trucks will turn into and leave the site from Shepherd Acton Road.

### How many trucks are expected each day?

5 to 10 trucks on a daily basis.


### How will the trucks be managed to prevent material from getting onto the road?

The trucks will be covered.

### Additional Information and Questions

### How do I learn more?

For more information, please visit the project Facebook page: Project Forward or contact Mary Green at 304-932-7673 or <a href="mage:mgreen@mage.info.">mgreen@mage.info.</a>

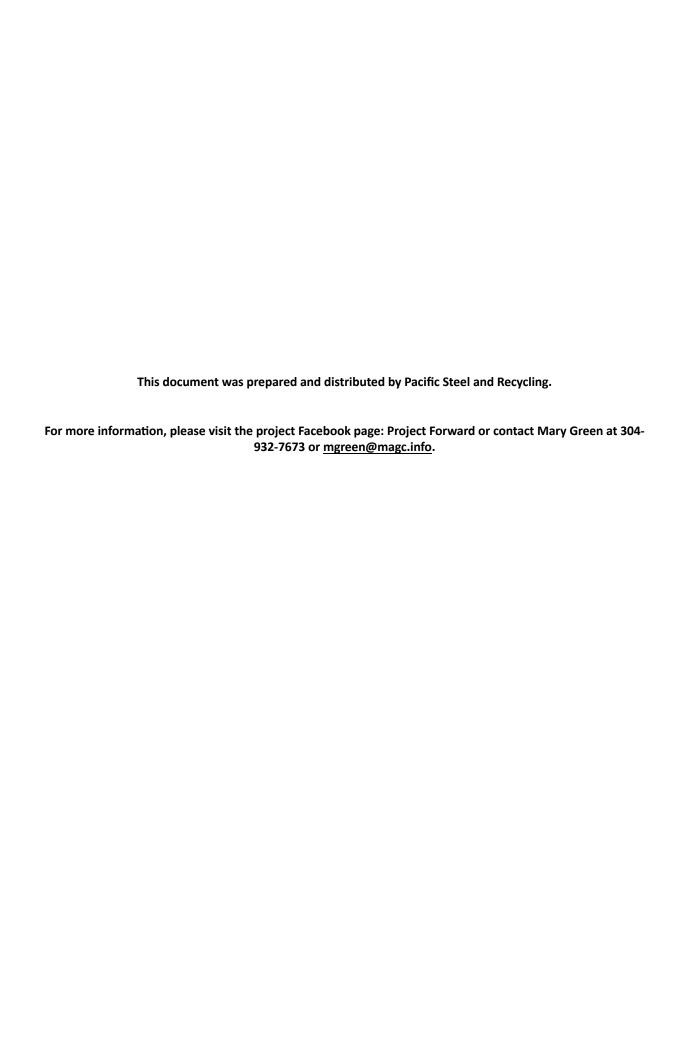

### **Project Forward Stakeholder Engagement and Outreach**

Sponsored by Pacific Steel and Recycling Report Prepared: November 20, 2023

Pacific Steel & Recycling began community engagement and outreach about the project in October 2021. Since that time, the company and its project team have communicated with 40 community members and leaders, sponsored an open house, set up a project Facebook Page, and participated in media interviews. This document provides insight into the work.

### **Stakeholder Groups (Meetings and Direct Communications)**

- Neighboring Landowners/Lessee
- Independent School
- Shepherd School
- o Yellowstone County Environmental Dept.
- Yellowstone County EMA
- Yellowstone County Extension Office
- Big Sky Economic Development
- Northern Plains Resource Council
- o Bureau of Land Management
- Yellowstone County News
- Shepherd Volunteer Fire Department
- Yellowstone County Health Department
- Yellowstone County Sheriff's Office
- Local, County, State, Federal Elected Officials

(See back page for outreach conducted.)

### Methods and Dates of Outreach and Engagement

### 2021

- October and November
  - o Initial Contact by Email/Phone Call
  - First Meeting/Introduction
  - Thank You Email/Update, Post Meeting

### 2022

- o August
  - Meetings and Visits
  - o Thank You Email and White Paper
- o December
  - o Email Letter from Marshall Re: Submittal
  - o Personal Call/Text to Tell Application Being Submitted/Look for Email
  - o FB Page Launched/Email

### 2023

- January
  - o Facebook Post (1)
- February
  - Facebook Post (1)
  - February Visits
- April
  - Facebook Post (1)
- o July
  - Open House Invitation
  - Facebook Post (2)
  - o Project Open House
  - Yellowstone County Newspaper Article
- August
  - Facebook Post (1)
- September
  - o Public Comment Period Email
- October
  - Facebook Post (5)
  - Postcard Mailing to 1400 Address
- o November
  - Facebook Post (5)
  - Yellowstone County Newspaper Article
  - Community Visit
  - o Channel 2 Interview
  - o Channel 8 Interview
  - Billings Gazette Interview
  - o Email about Public Meeting

# Our Environmental & Safety Commitment....

At Pacific Steel & Recycling, we strive to be the best environmental stewards we can be in the communities we're a part of and we kindly ask that our customers help us with this commitment in the material they bring to us.

In this pamphlet, you'll find a general overview of our "Material Acceptance Standards" that should assist you, as our valued customer, in getting to know what items at this PS & facility we don't recycle and consider as "prohibited items."

If you have any additional questions related to this pamphlet or the info therein, please don't hesitate to contact any one of our employee-owners as we'd be happy to assist.

Thank you again for choosing Pacific Steel & Recycling as your local recycler and here's to making our communities a better place.






for choosing Pacific!







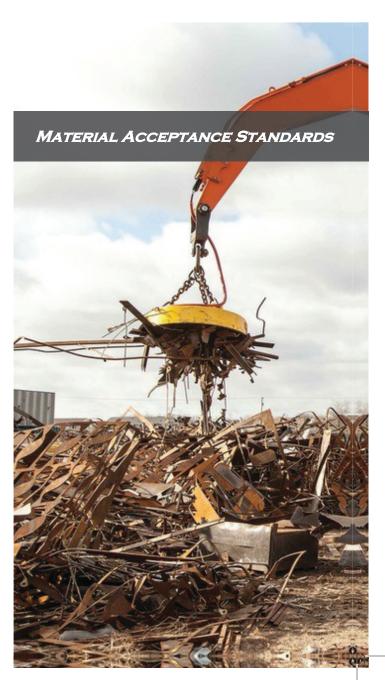





### PROHIBITED-ITEMS

- Radioactive Materials (or, items with a radioactive label, ie. X-ray equipment, military/airplane gauges, smoke detectors, TENORM, etc.)
- Explosive Materials/ Live Munitions (including loaded frac-pipe and all live ammunition shells)
- Pressurized Gas Cylinders/Sealed Containers (must be devalved or visibly vented with adequate size hole)
- Tanks/Drums (w/out Empty Tank Certificates and proper venting/holes)
  - Accumulators (w/out Empty Tank Certificate, plugs removed, drained and remediated)

Flammable Liquids

(i.e. separated oil/gasoline)

- Items w/ Flammable Liquids (i.e. lawnmowers, tractors, other hydraulic equipment. Please drain fluids prior to our acceptance)
- Lithium-Ion Batteries (unless source-separated from rechargeable electronics, hybrid-autos, etc.)



### Prohibited-Items

Asbestos (i.e. friable or non-friable > than 1%)



**Biohazards** (i.e. medical wastes, needles, other)



Chemicals/Hazardous Wastes (i.e. poisons, household cleaning supplies,



- AC Compressors/ Fridges (w/out CFC evacuation certification or if PS&R facility does not have capacity to properly remediate)
  - Ballasts, Transformers or Capacitors (w/out "Non-PCB" label or documentation showing under 50ppm)
- Mercury (i.e. fluorescent lights, thermometers, other)



Aerosol Cans (unless punctured and drained)



Oil filters (unless drained via "hot method")





### PROHIBITED-ITEMS

**Paint Cans** (unless completely dry and less than 5 gallons)



Other Household Batteries (AAA, AA, D, NiCd, NiMH, other. Please remove from items prior to our acceptance)



Yard Wastes/Other (i.e. dirt, grass, leaves, rock, wood, carpet, garbage, concrete, rubber, glass, and plastic)













January 23, 2024

Mr. Fred Collins, Solid Waste Section Supervisor Solid Waste Section Montana DEQ P.O. Box 200901 Helena, MT 59620-0901

Re: License Application for Auto Shred Residue (ASR) Repository Supplemental Licensing Information

Dear Fred:

In consideration of comments received during the public comment period for the above referenced license application, we are submitting the following supplemental information for the Department's consideration.

### **Project Design Additions**

We have several design additions which have been included in the revised Master Plan drawings which are enclosed. Specific design additions include the following:

### 1) GCL Liner Enhancement for Leachate Pipes and Sump

Pacific Steel previously agreed to place a geosynthetic clay liner (GCL) under the footprint of leachate collection trenches and sumps within the lined areas of the cells. This has been added to the details within the updated Master Plan drawings. Additional details will be provided within the final construction drawings for the Phase 1 cell.

### 2) Rural Fire Fighting Water Cistern/Dry Hydrant

The location of the cistern has been included in the master plan drawings. Details for the cistern will meet the requirements of the Shepherd Volunteer Fire Department and will be included in the final construction drawings for the Phase 1 cell.

### 3) Off Site Tracking Control

An off-site vehicle tracking mat and two cattle guards will be installed on Pacific's entrance approach road where it leaves the Shepherd Acton Road as shown on Sheet 3 of the revised Master Plan drawings. Details will be included on the final construction drawings for Cell 1.

### 4) Storm Water Controls

All the stormwater conveyances and storm water ponds will be upgraded to a 100-year, 24 hour storm event. The revised calculations and design for the ponds

### HELENA

2501 Belt View Drive Helena, MT 59601 Ph: (406) 449-8627 F: (406) 449-8631

### BILLINGS

6780 Trade Center Avenue Billings, MT 59101 Ph: (406) 652-5000 F: (406) 248-1363

### BOISE

1921 E Overland Road Meridian, ID 83642 Ph: (208) 576-6646

### **GREAT FALLS**

702 2nd Street Ste #2 Great Falls, MT 59405 Ph: (406) 952-1109

### SPOKANE

10220 N Nevada Street Suite 130 Spokane, WA 99218 Ph: (509) 413-1430

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and conveyances will be submitted to DEQ with the final construction drawings for the Phase 1 cell project.

### **Operations Enhancements**

Pacific has agreed to several enhancements to its operations and maintenance plan for the facility. Once these specific commitments are accepted by the DEQ they will be incorporated in the final operations plan for the facility. Specific commitments are as follows:

### 1) ASR Management and Dust Control

In addition to the implementation of daily cover and compaction of the ASR, Pacific Steel agrees to the following management procedures to deal with proper control of the ASR during wind events:

- a. All ASR loads transported to the repository will be transported in walking floor trailers that are tarped to control material loss.
- b. Pacific Steel will install an anemometer at the repository site to continuously measure wind speed at the site.
- c. When continuous wind speeds as defined by a ten-minute period exceed 35 mph, Pacific will immediately place and compact ASR upon arrival on site to mitigate windblown material.
- d. When continuous wind speeds exceed 45 mph, Pacific will close the facility until wind speeds have subsided for at least two hours before reinitiating operations.
- e. When instantaneous wind gusts exceed 55 mph, Pacific will close the facility until wind speeds have subsided for at least two hours before reinitiating operations.
- f. Pacific Steel has also committed to the installation of litter fences around the active working area to control ASR which will be periodically cleaned by site personnel.
- g. If during ASR unloading, dust is observed to be visibly leaving the licensed facility boundary, Pacific Steel will utilize a Dust Boss misting system to prevent dust transport off site. This is a nationally accepted and proven dust control approach for dust generating activities.

### 2) ASR Testing

Pacific has utilized a detailed sampling and waste characterization plan for testing ASR generated from its shredders at Mayfield, ID and Lockwood, MT for the last 15 years. This includes quarterly TCLP and PCB as well as annual volatile and semi-volatile testing. Data from this testing shows that over 97% of the results to date have resulted in a non-hazardous determination. The plan also outlines protocol if testing determines that a specific ASR load is hazardous. This includes quarantining the material and shipping it to a hazardous waste facility for disposal in compliance with State and Federal requirements.



Pacific will include its sampling, waste characterization and hazardous waste disposal plan in the final operations and maintenance plan for the repository. As part of the specific plan for the repository, Pacific is committing to increasing the TCLP test frequency to every two months (bi-monthly) for the first year of the operation. If testing is clean during this period, Pacific will revert to quarterly TCLP testing thereafter.

If you have any follow-up questions or concerns, please contact me at my office.

Sincerely,


Great West Engineering, Inc.

Robert Church, PE

Senior Project Manager

cc: Pacific Steel and Recycling

Rick Thompson, DEQ

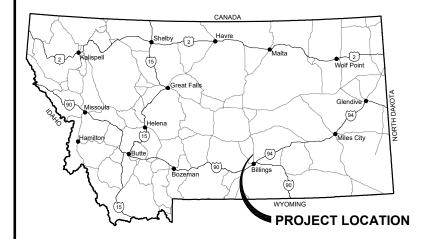

# **PACIFIC STEEL & RECYCLING AUTO SHRED RESIDUE (ASR)** REPOSITORY MASTER PLAN

SECTION 03, TOWNSHIP 02N, AND RANGE 26E

### PLANS PREPARED FOR:

**PACIFIC STEEL & RECYCLING** 



### APPROVED BY:

ROBERT E. CHURCH, P.E. GREAT WEST ENGINEERING



### QA/QC BY:


STEPHANIE M. BECKERT, P.E. GREAT WEST ENGINEERING



### PLANS PREPARED BY:

BRET ANDERSON STETSON RATZLAFF, EI



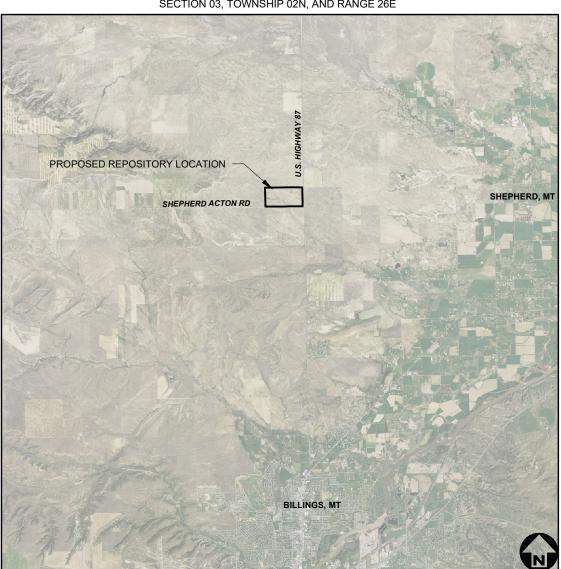

NOT TO SCALE

### SHEET INDEX

ROJECT: 1-20288 DATE: JANUARY 16, 2024


SHEET 1	COVER
SHEET 2	LEGEND, ABBREVIATIONS, AND GENERAL NOTES
SHEET 3	SEQUENCE PLAN
SHEET 4	OVERALL CUT PLAN
SHEET 5	OVERALL FILL PLAN
SHEET 6	CROSS SECTIONS
SHEET 7	CROSS SECTIONS
SHEET 8	CROSS SECTIONS
SHEET 9	PHASE 1 EXCAVATION PLAN
SHEET 10	CROSS SECTIONS
SHEET 11	PHASE 1 WASTE AND PHASE 2 EXCAVATION PLAN
SHEET 12	CROSS SECTIONS
SHEET 13	PHASE 2 WASTE AND PHASE 3 EXCAVATION PLAN
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SHEET 17	CROSS SECTIONS
SHEET 18	PHASE 4 WASTE PLAN
SHEET 19	CROSS SECTIONS
SHEET 20	DETAILS
SHEET 21	DETAILS
SHEET 22	DETAILS
SHEET 23	DETAILS
SHEET 24	DETAILS
SHEET 25	DETAILS

Ο.	REVISION DESCRIPTION	BY	DATE	SET NO.
1	ADD CISTERN, GCL, TRACKOUT MAT & CATTLE GUARD	STR	1/15/24	
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### **LEGEND** EXISTING PROPOSED DESCRIPTION **EXISTING** PROPOSED DESCRIPTION MAJOR CONTOUR STUMP — MINOR CONTOUR 0 SHRUB/BUSH OHT — OVERHEAD TELEPHONE TREE-CONIFER UGT — UGT — UNDERGROUND TELEPHONE TREE-DECIDUOUS CTV — CTV — CABLE TELEVISION TREE LINE FO — FO — FIBER OPTIC (0) (C) COMMUNICATION MANHOLE G ----- G ----- NATURAL GAS С С COMMUNICATION VALUET OVERHEAD POWER TELEPHONE RISER UNDERGROUND POWER CABLE TV RISER - SANITARY SEWER 0 NATURAL GAS METER - SANITARY SEWER FORCEMAIN NATURAL GAS RISER - STORM DRAIN Ø Ø NATURAL GAS VALVE \_ \_ STORM CULVERT Ø LIGHT POLE ■ WATER STREET LIGHT POLE O O O O O O CHAINLINK FFNCF POWER RISER $\blacksquare$ PAD MOUNTED TRANSFORMER WOOD FENCE Р Р POWER VALUET PAVED ROAD 9 UTILITY POLE \_ GUY WIRE GRAVEL ROAD S S SANITARY MANHOLE PROPERTY/LOT LINE **© 60** SANITARY CLEANOUT \_\_\_\_\_ PROPERTY EASEMENT SANITARY LAMPHOLE ------ PROPERTY SETBACK **(T)** (ST) STORM MANHOLE 0 0 STORM ROUND INLET STORM SQUARE INLET STORM CATCH BASIN WETLAND FIRE HYDRANT a BUILDING $\bowtie$ M GATE VALVE REDUCER -(W) (W) WELL CONTROL POINT 0 0 CURB STOP PROPERTY PIN FROST FREE HYDRANT BORING BOLLARD MONITORING WELL

### **GENERAL NOTES:**

- THIS IS A STANDARD LEGEND AND ABBREVIATION LIST. THEREFORE, NOT ALL SYMBOLS AND ABBREVIATIONS MAY BE USED ON THIS PROJECT.
- 2. UNLESS MODIFIED BY THE CONTRACT DOCUMENTS, ALL WORK WILL CONFORM TO THE MONTANA PUBLIC WORKS STANDARD SPECIFICATIONS, SIXTH EDITION, APRIL 2010 (REFERRED TO COLLECTIVELY AS MPWSS).
- 3. EXISTING UNDERGROUND UTILITIES SHOWN ARE FROM THE BEST INFORMATION AVAILABLE. THIS INFORMATION IS APPROXIMATE AND MAY BE INCOMPLETE. FOR ACCURATE LOCATION, THE CONTRACTOR SHALL CONTACT, PRIOR TO EXCAVATION, THE UTILITIES UNDERGROUND LOCATION CENTER AT: 1–800–424–5555.

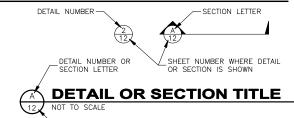

SHEET NUMBER WHERE DETAIL

### **SOIL & WASTE BALANCE TABLE**

TEST PIT

Phase	Total Airspace Waste and Daily Cover(CY)	Waste Volume (CY)	Daily Cover (CY)	Final Cover (CY)	Total Soil Required (CY)	Total Fill Required for Construction (CY)	Total Excavation (CY)	Tonnage (Tons)	Life (Years)	Soil Balance (CY)
Roads, Ditches, Ponds						22,927	75,248			52,321
Phase 1	202,637	168,864	33,773	9,481	43,254	423	158,506	77,255	3	114,829
Phase 2	331,886	276,572	55,314	13,868	69,182	0	241,881	126,532	5	172,699
Phase 3	329,527	274,606	54,921	14,050	68,971	0	112,478	125,632	5	43,507
Phase 4	839,938	699,948	139,990	61,132	201,122	0	123,208	320,226	13	-77,914
Remaining Landfill	6,327,203	5,272,669	1,054,534	501,876	1,556,410	1,109	1,710,718	2,412,246	96	153,199
Total Class II	8,031,191	6,692,659	1,249,445	600,407	1,938,939	1,109	1,833,926	3,061,891	122	458,641

THE WASTE TO SOIL RATIO IS 5:1

THE ASSUMED WASTE DENSITY IS 915 LB/CY.
THE FINAL FILL SLOPES WILL BE 4:1.
THE TOP DECK ELEVATION VARIES 3386 FEET TO 3424 FEET.


5. THE LIFE IS BASED ON 25,000 TONS/YEAR.


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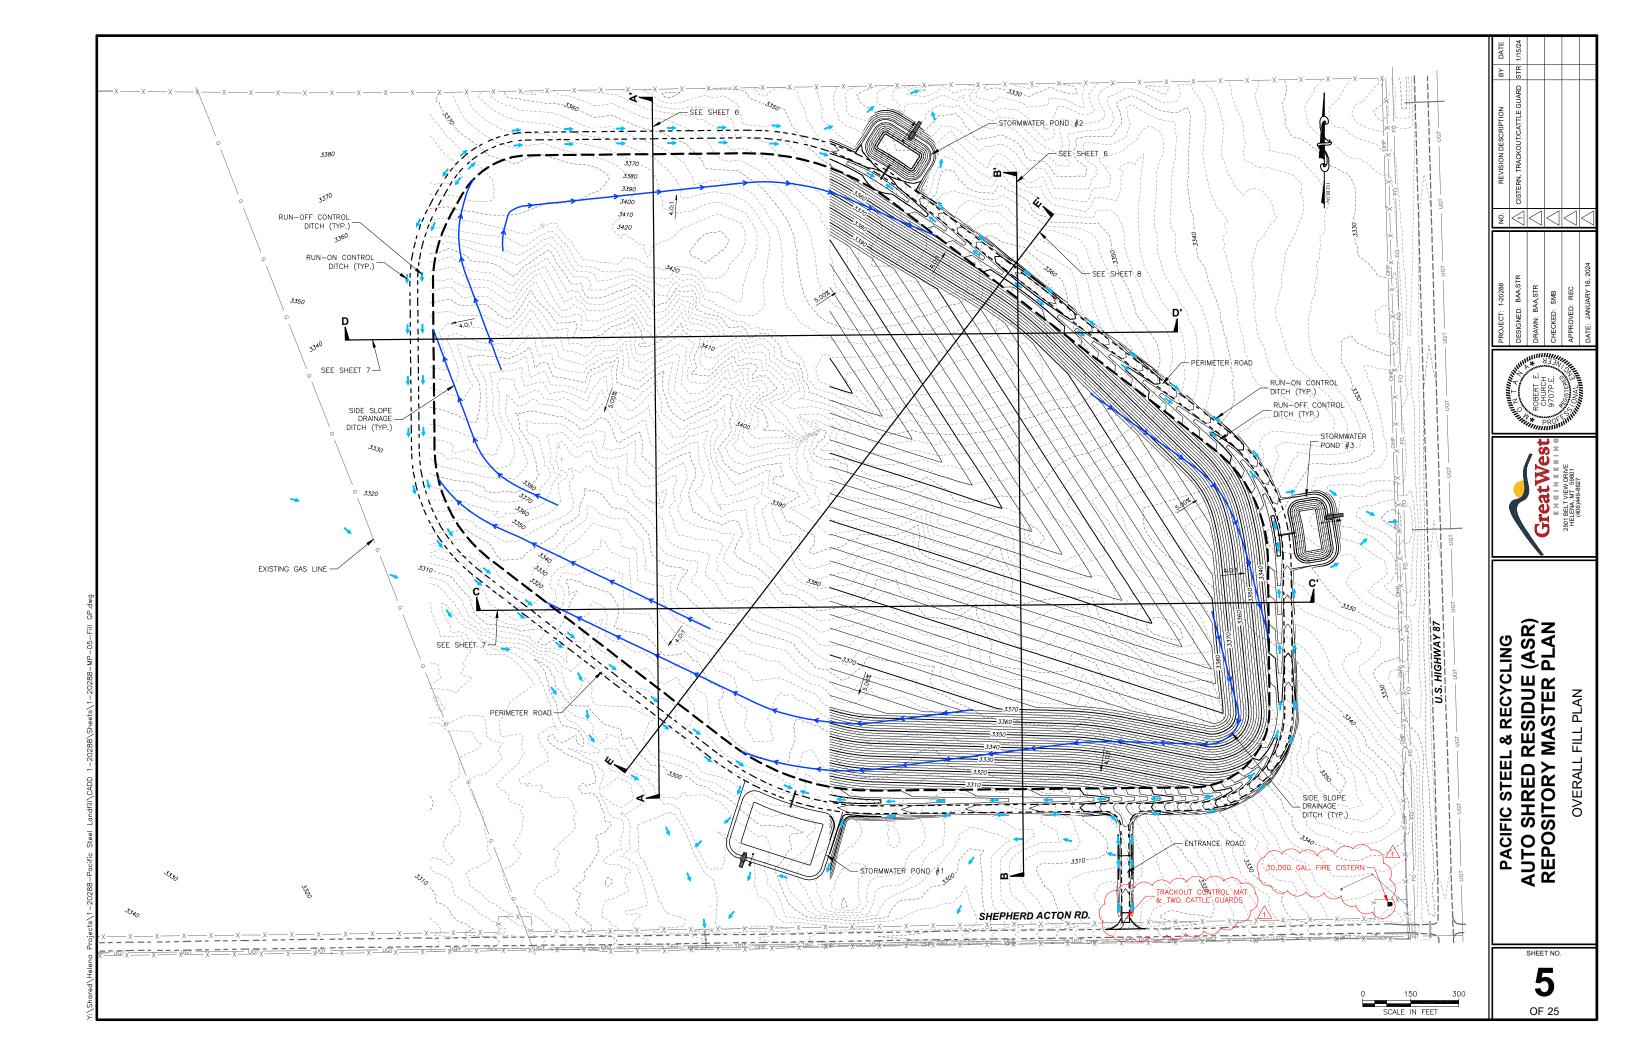
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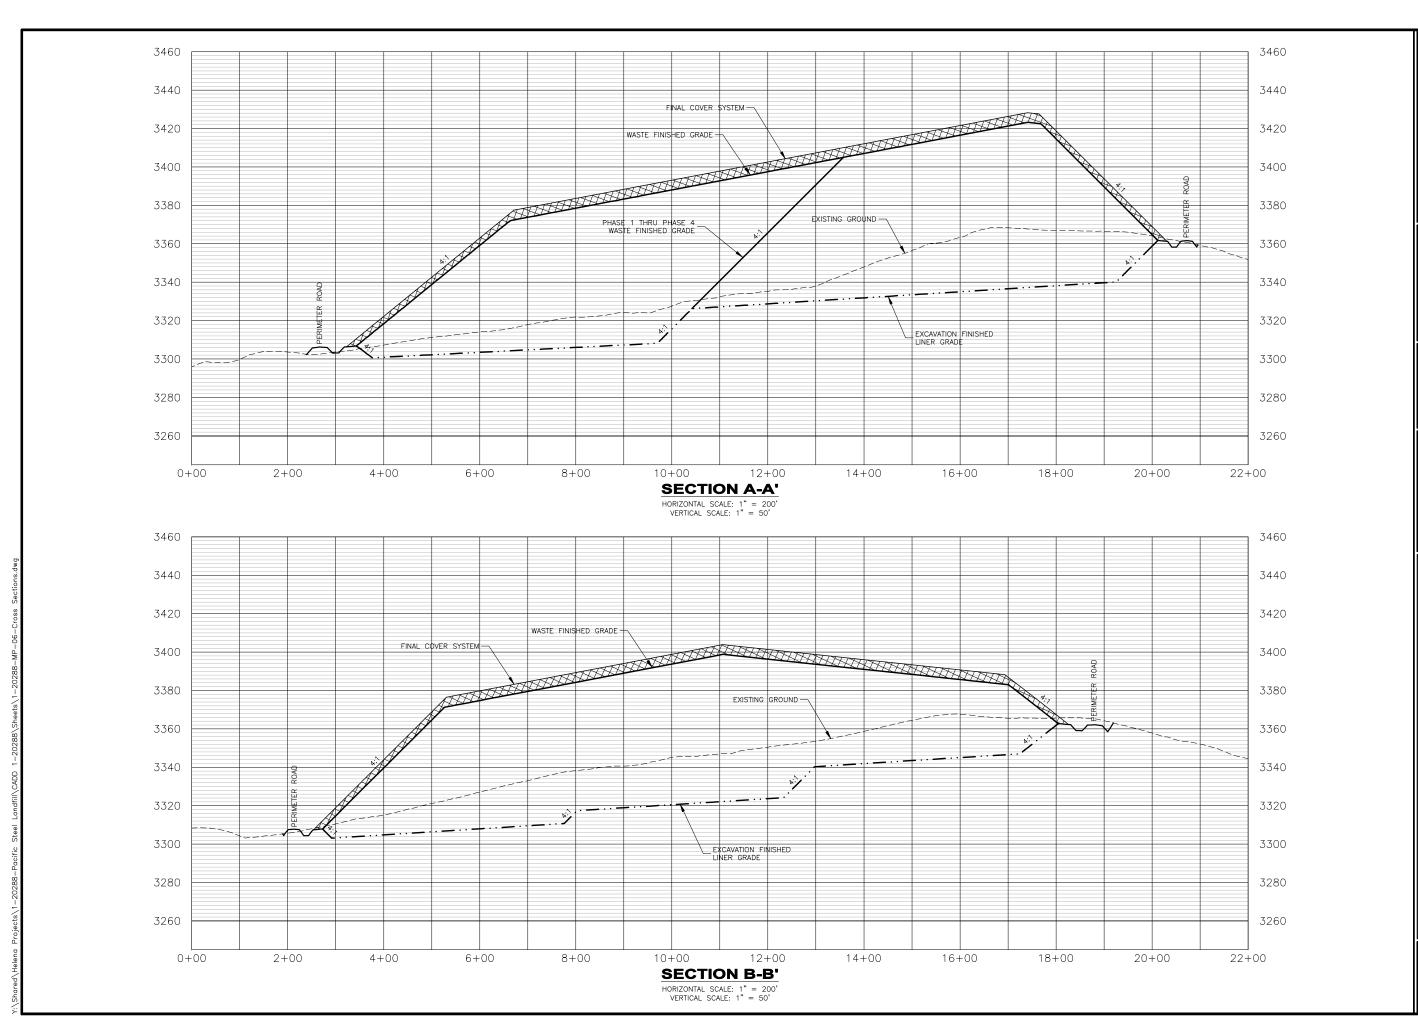
OF 25

\_ \_\_ . . . **GENERAL DESIGN DESIGNATIONS:** 





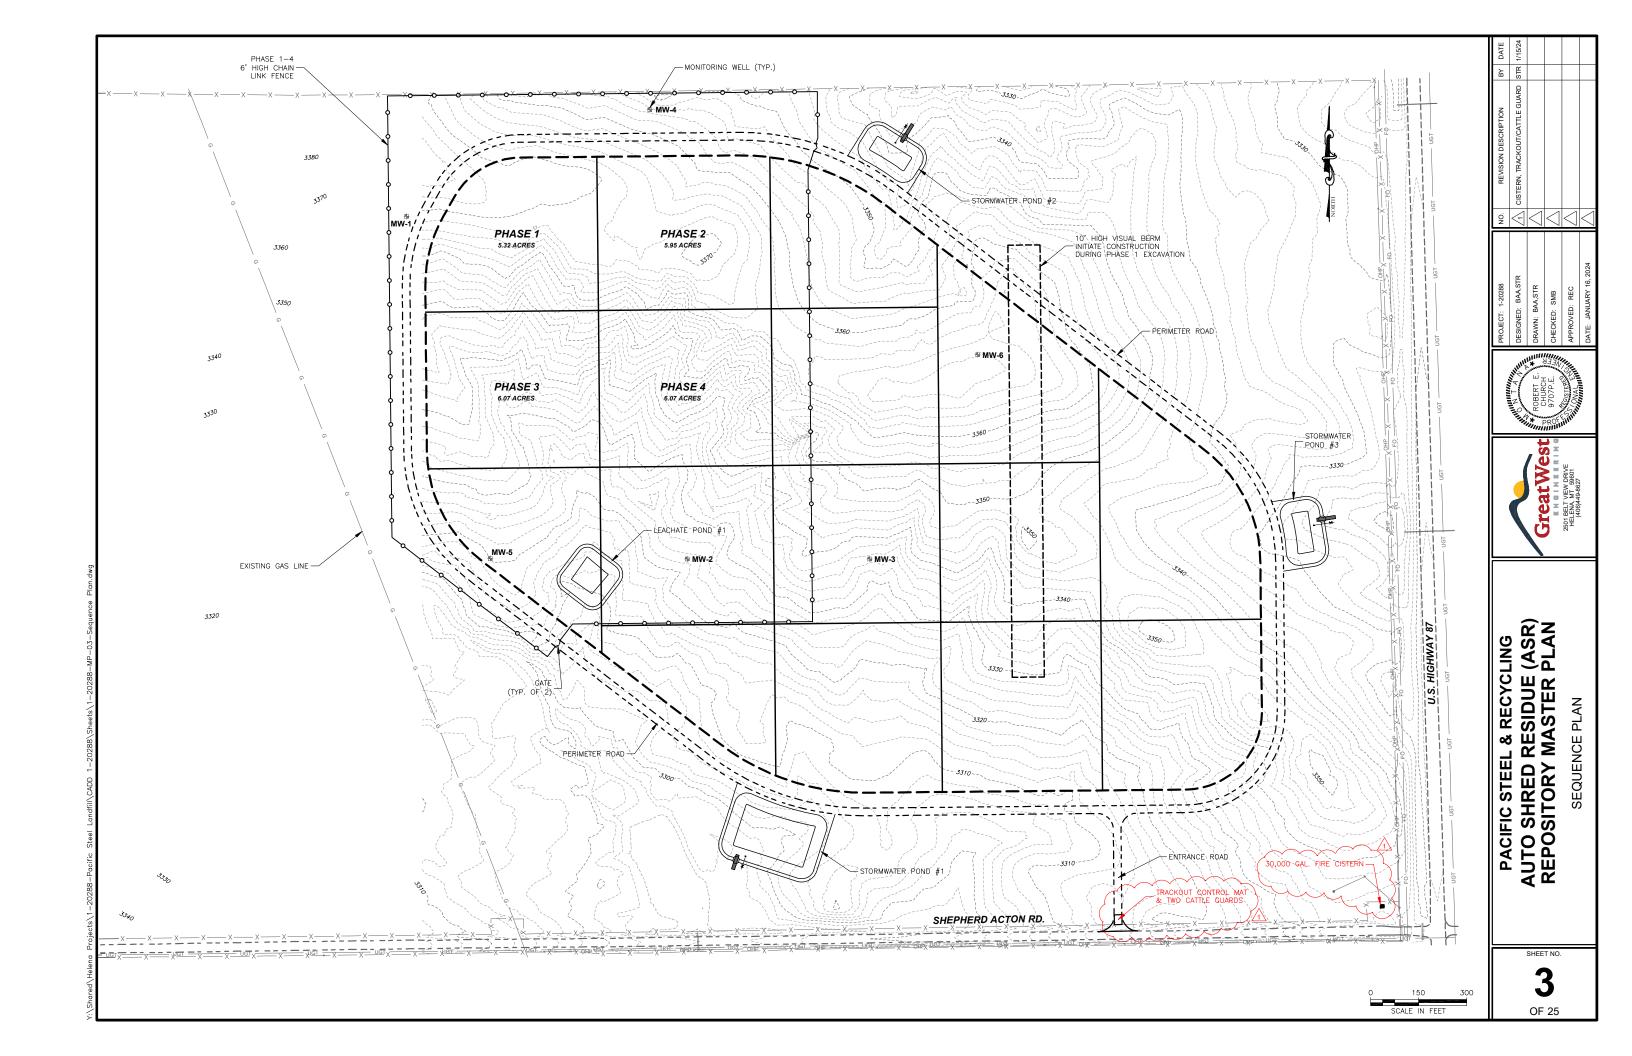

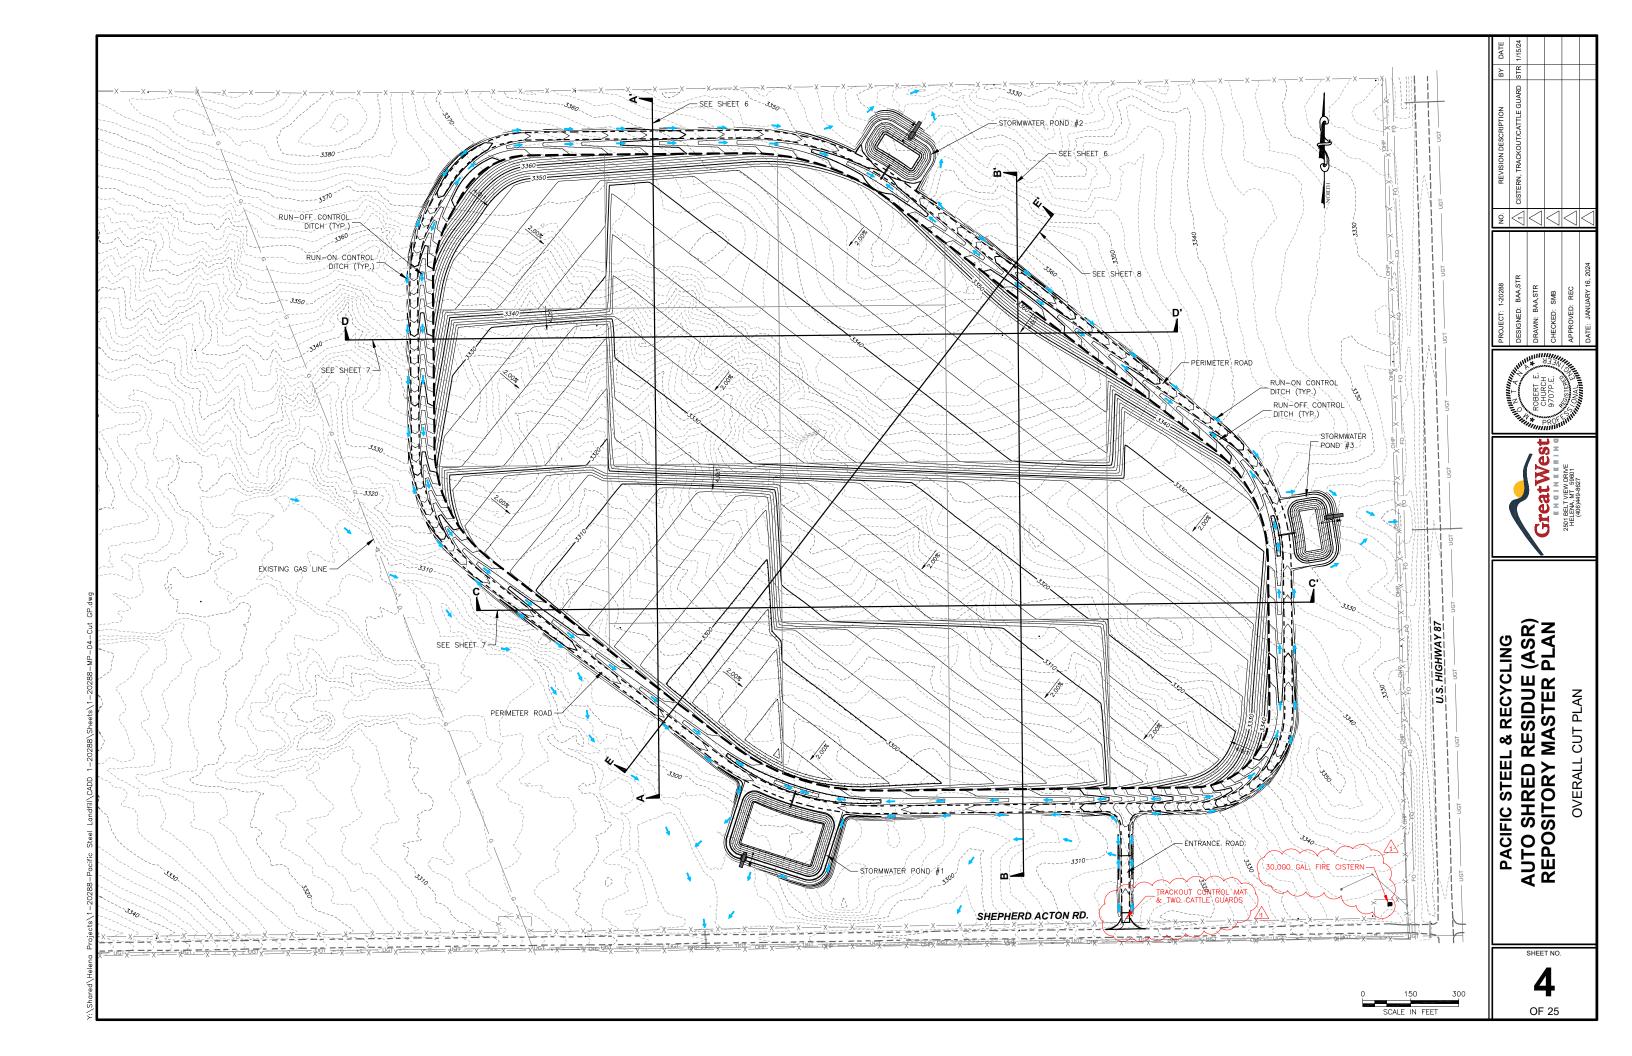





PACIFIC STEEL & RECYCLING AUTO SHRED RESIDUE (ASR) REPOSITORY MASTER PLAN

CROSS SECTIONS

SHEET NO. 6 OF 25

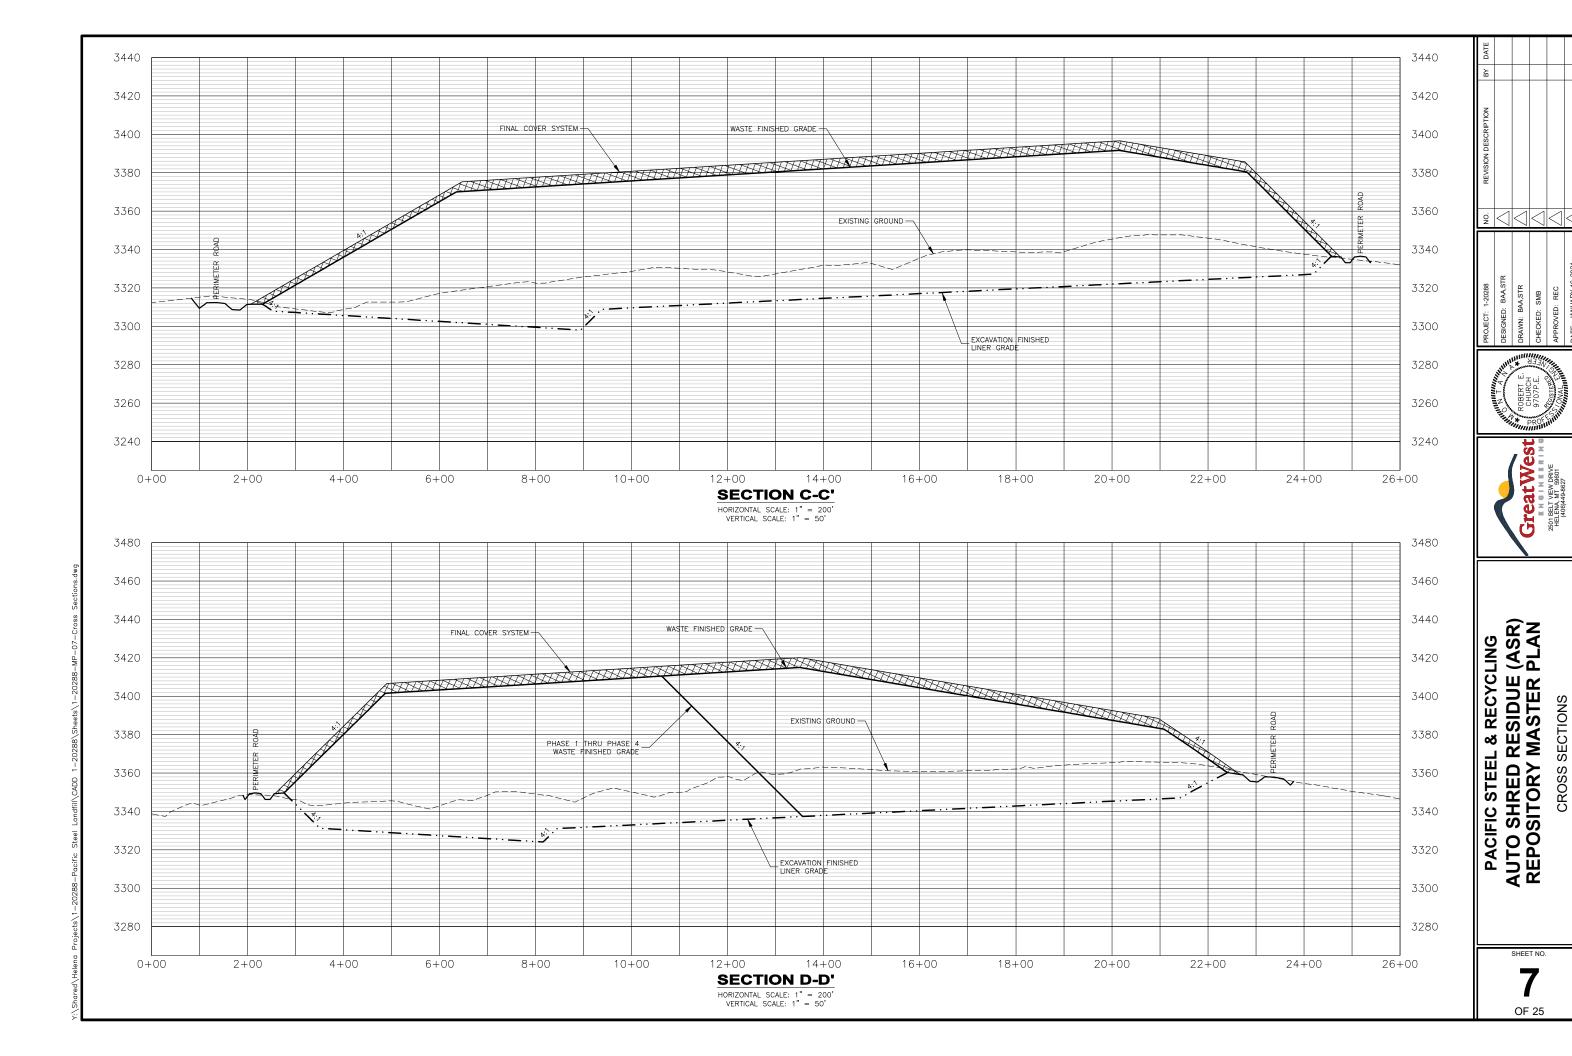


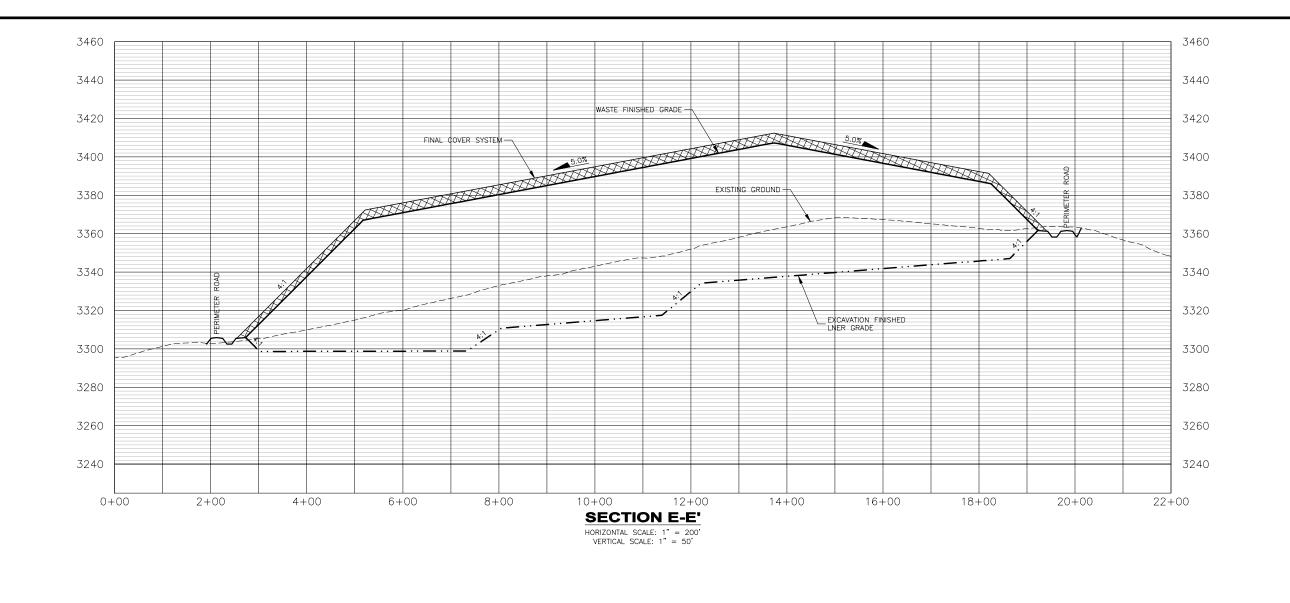



PACIFIC STEEL & RECYCLING AUTO SHRED RESIDUE (ASR) REPOSITORY MASTER PLAN

CROSS SECTIONS

SHEET NO. 8

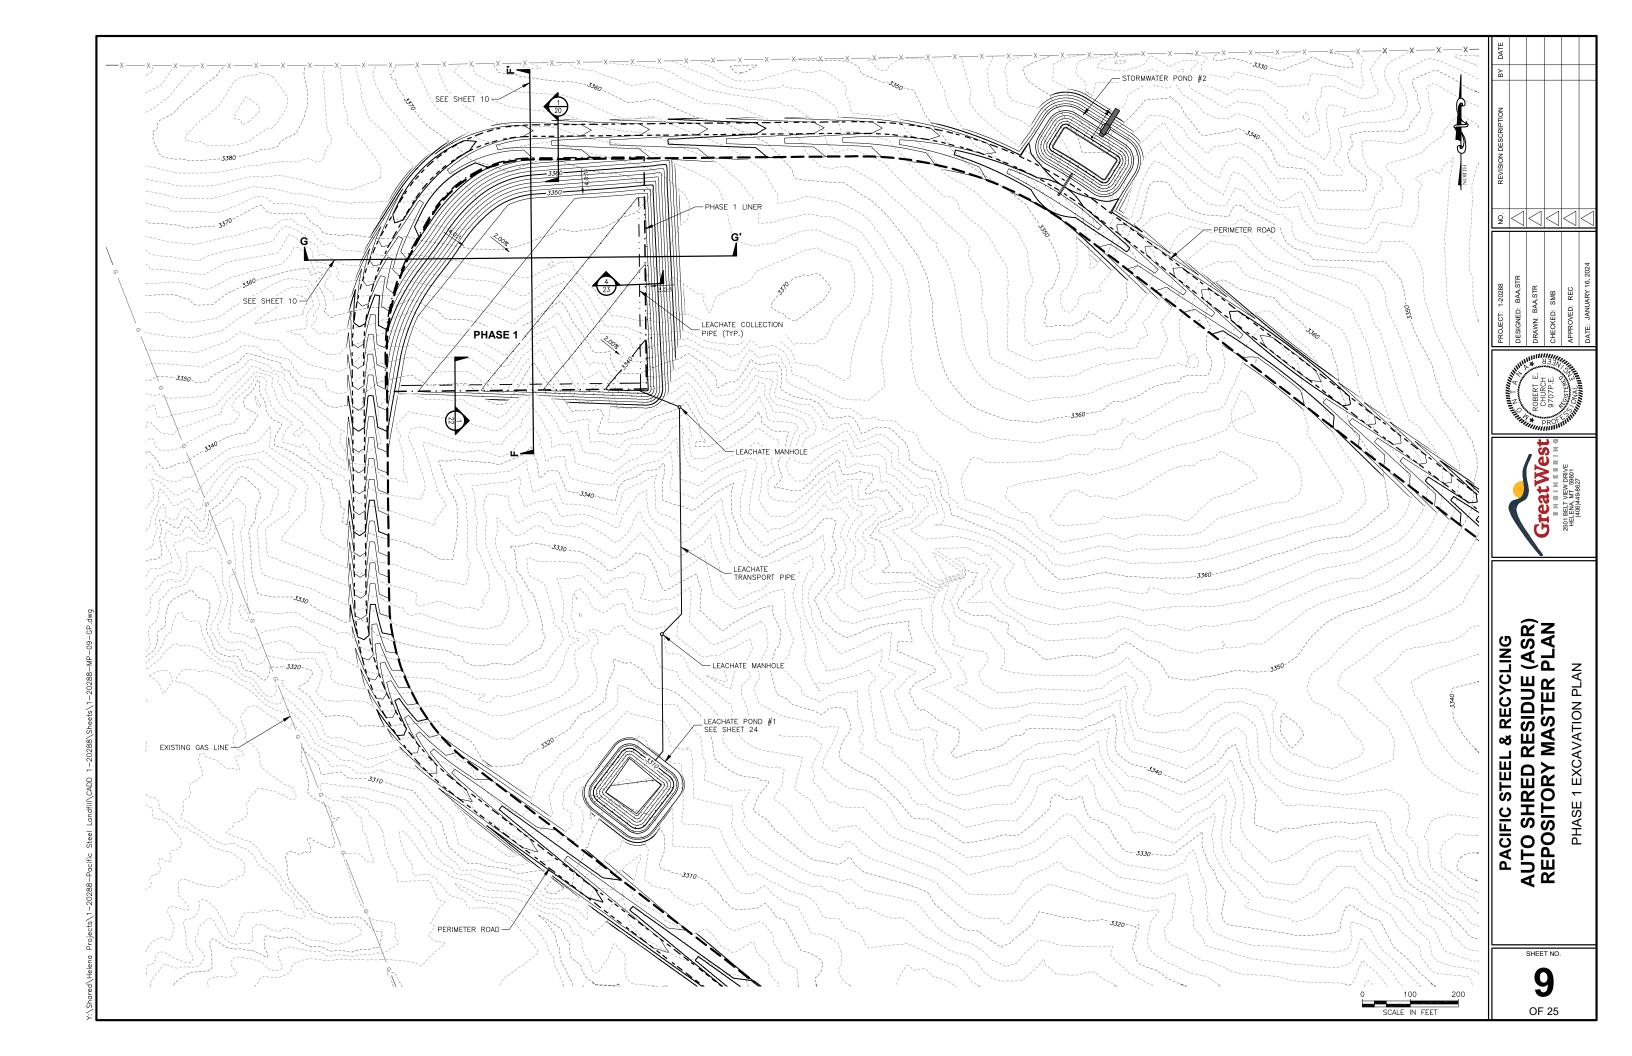

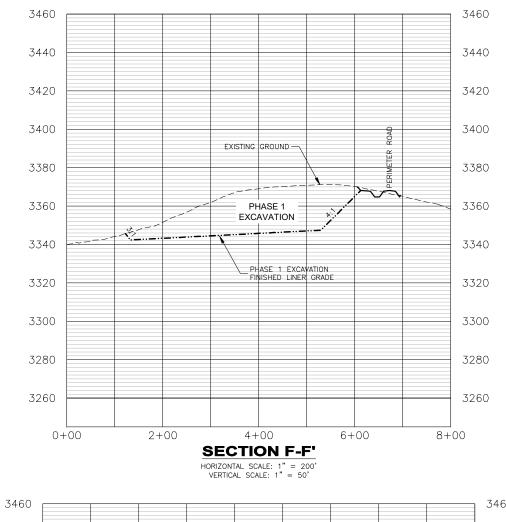

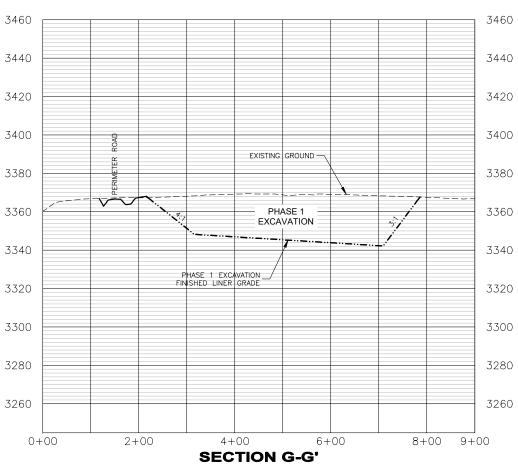

HORIZONTAL SCALE: 1" = 200' VERTICAL SCALE: 1" = 50' GreatWest
IN

GreatWest


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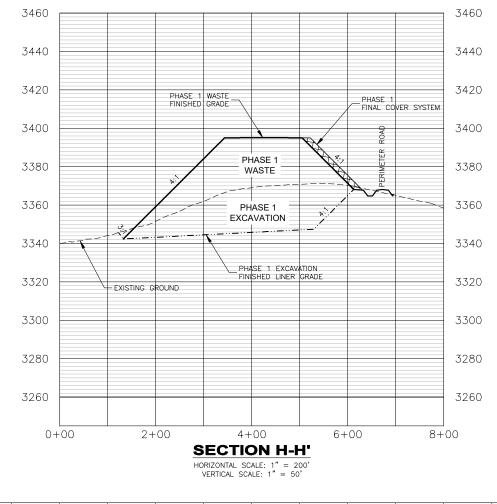
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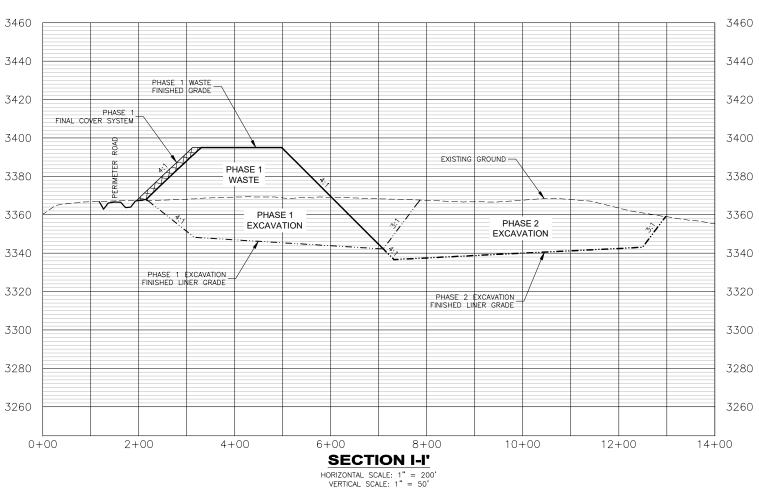
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PACIFIC STEEL & RECYCLING
AUTO SHRED RESIDUE (ASR)
REPOSITORY MASTER PLAN
CROSS SECTIONS










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PACIFIC STEEL & RECYCLING
AUTO SHRED RESIDUE (ASR)
REPOSITORY MASTER PLAN
CROSS SECTIONS

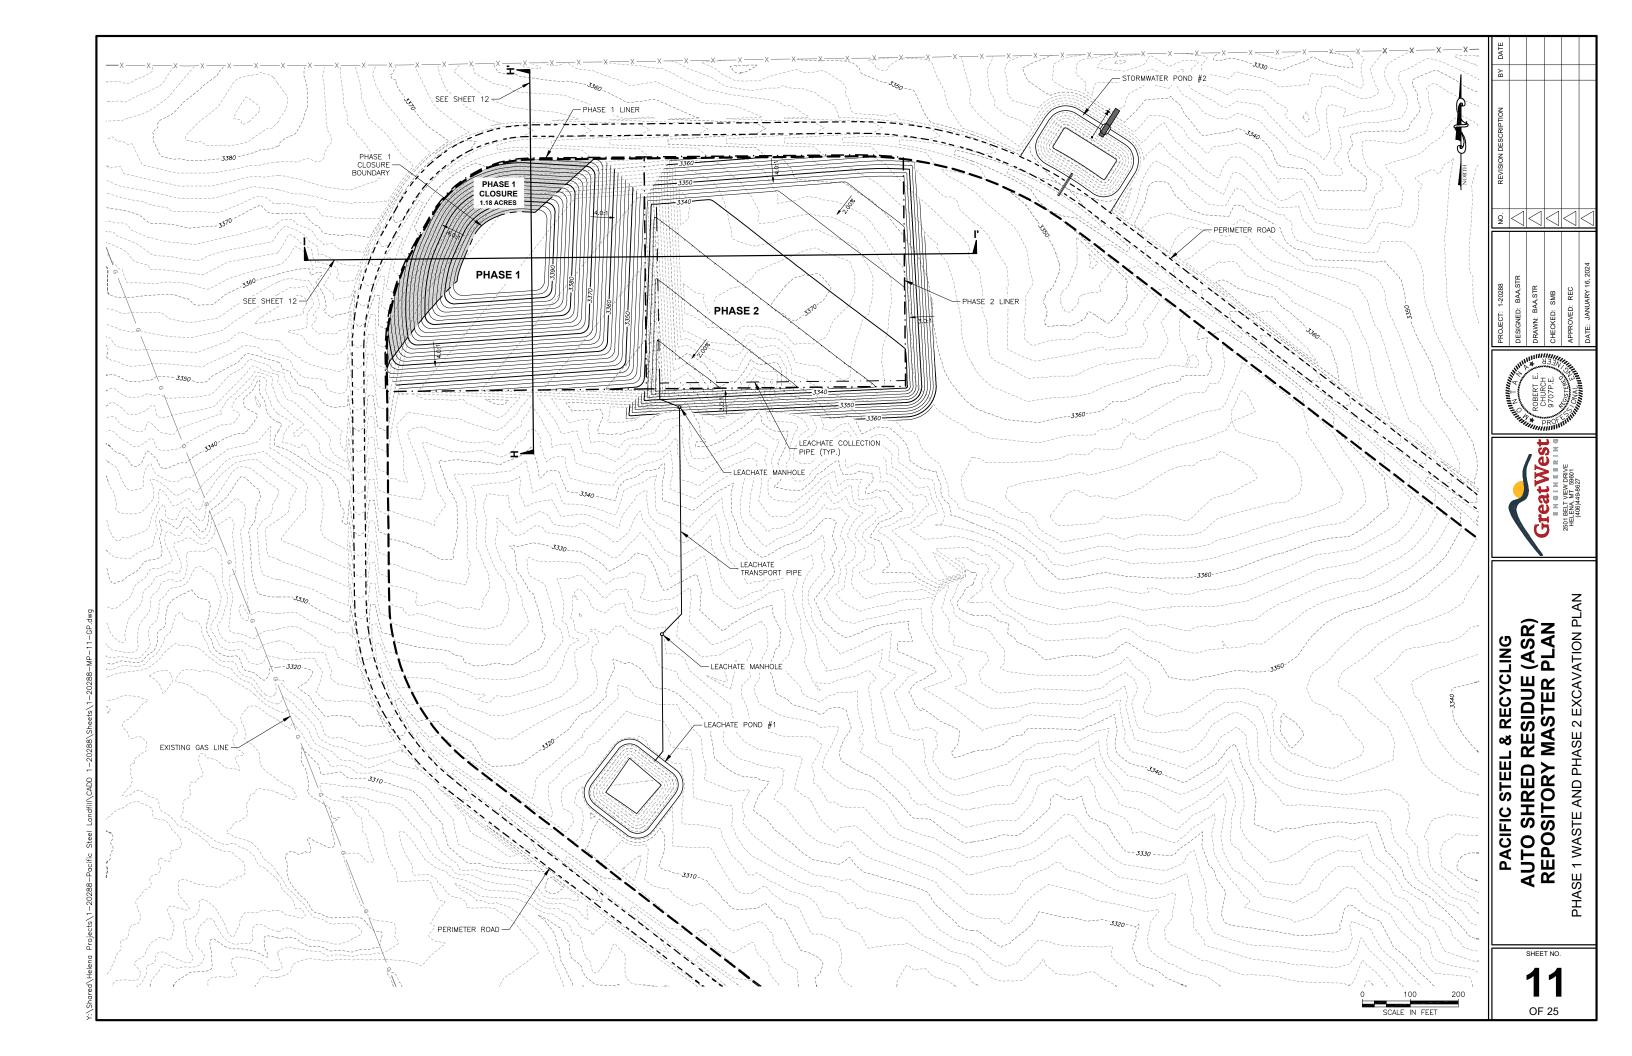

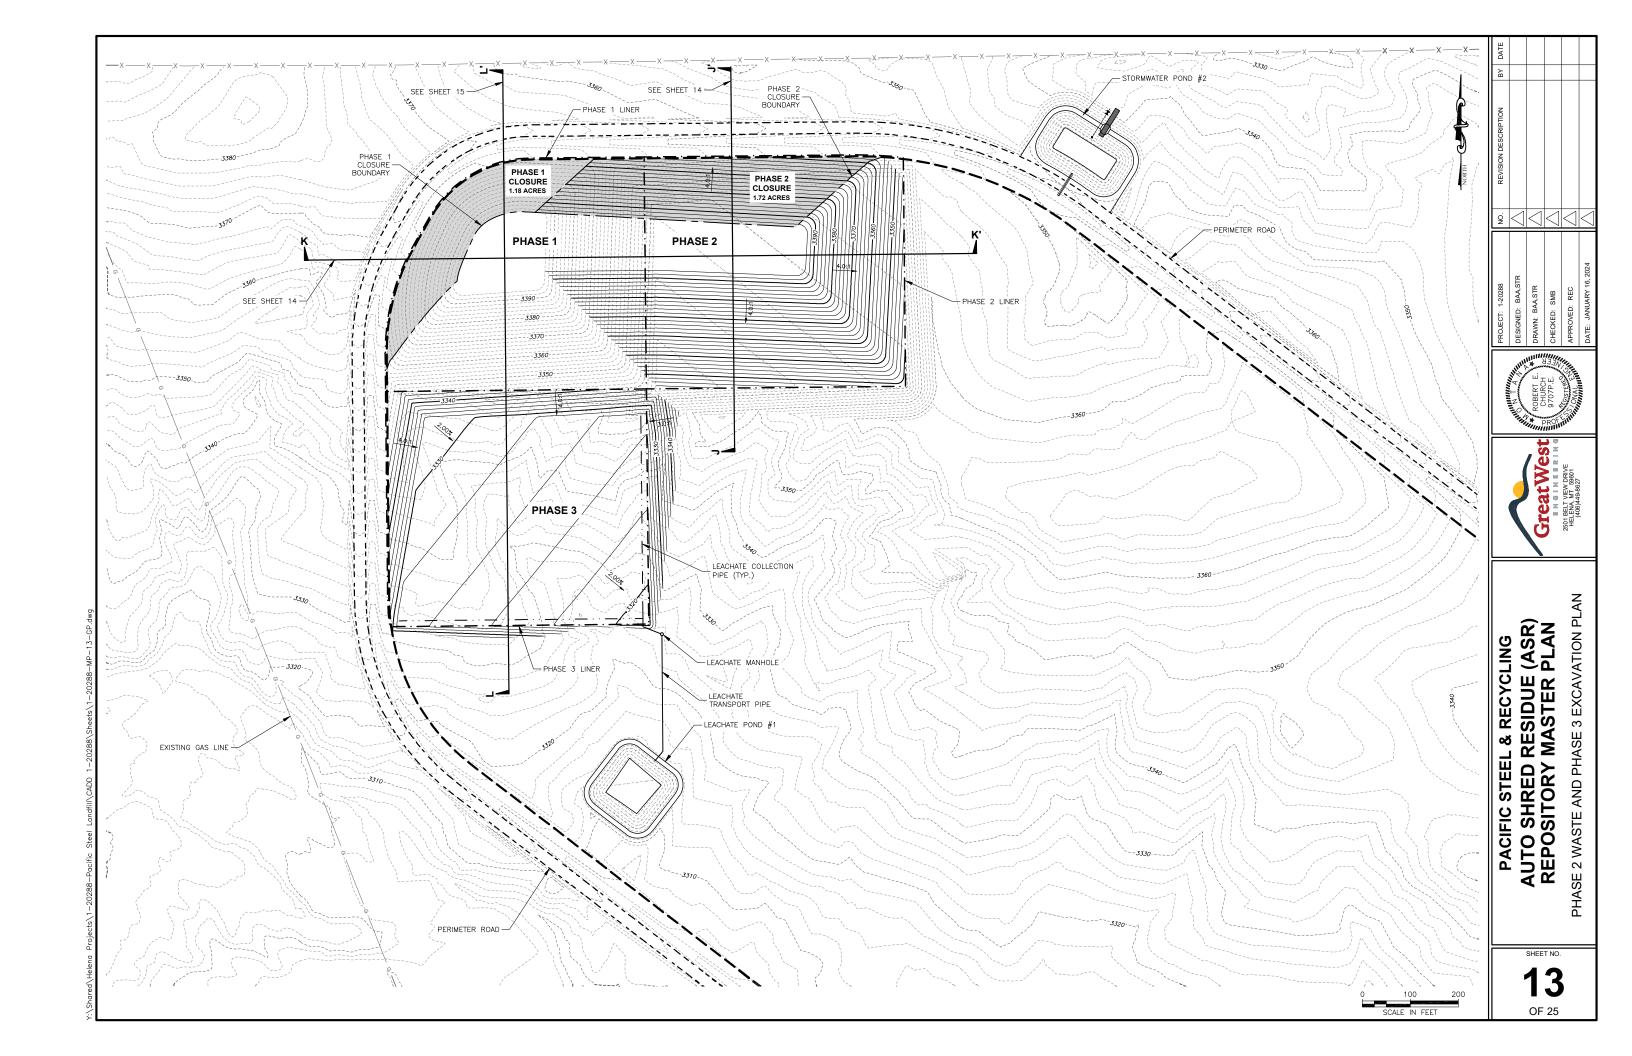


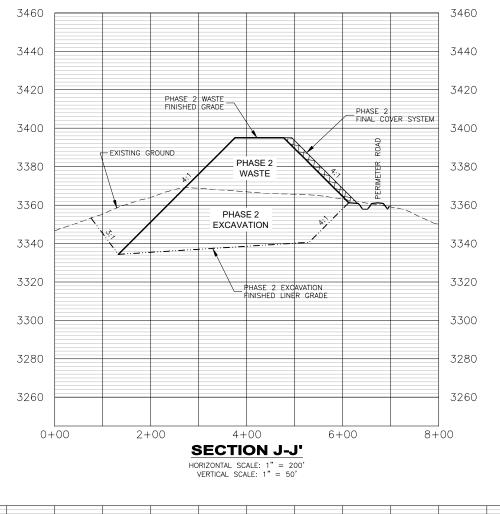

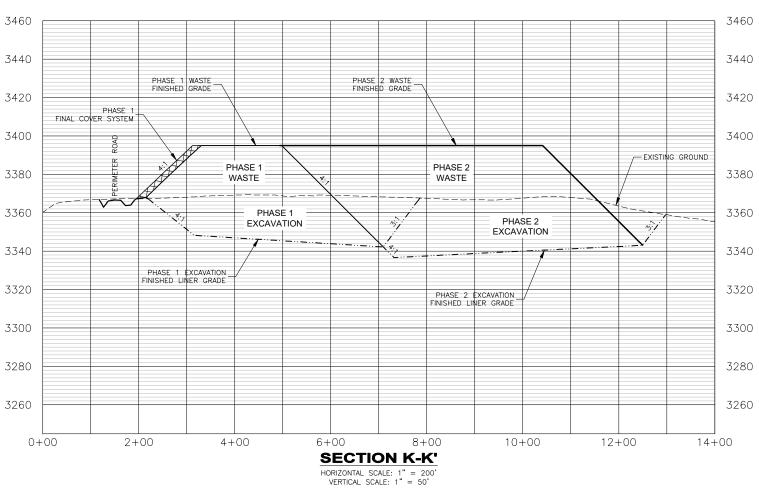SHEET NO. 14 OF 25

PACIFIC STEEL & RECYCLING AUTO SHRED RESIDUE (ASR) REPOSITORY MASTER PLAN

CROSS SECTIONS

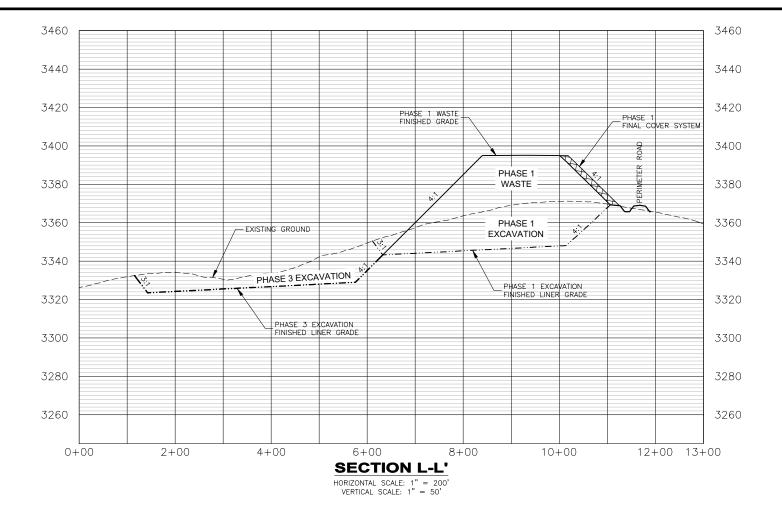








# PACIFIC STEEL & RECYCLING AUTO SHRED RESIDUE (ASR) REPOSITORY MASTER PLAN

CROSS SECTIONS

SHEET NO. **15** 

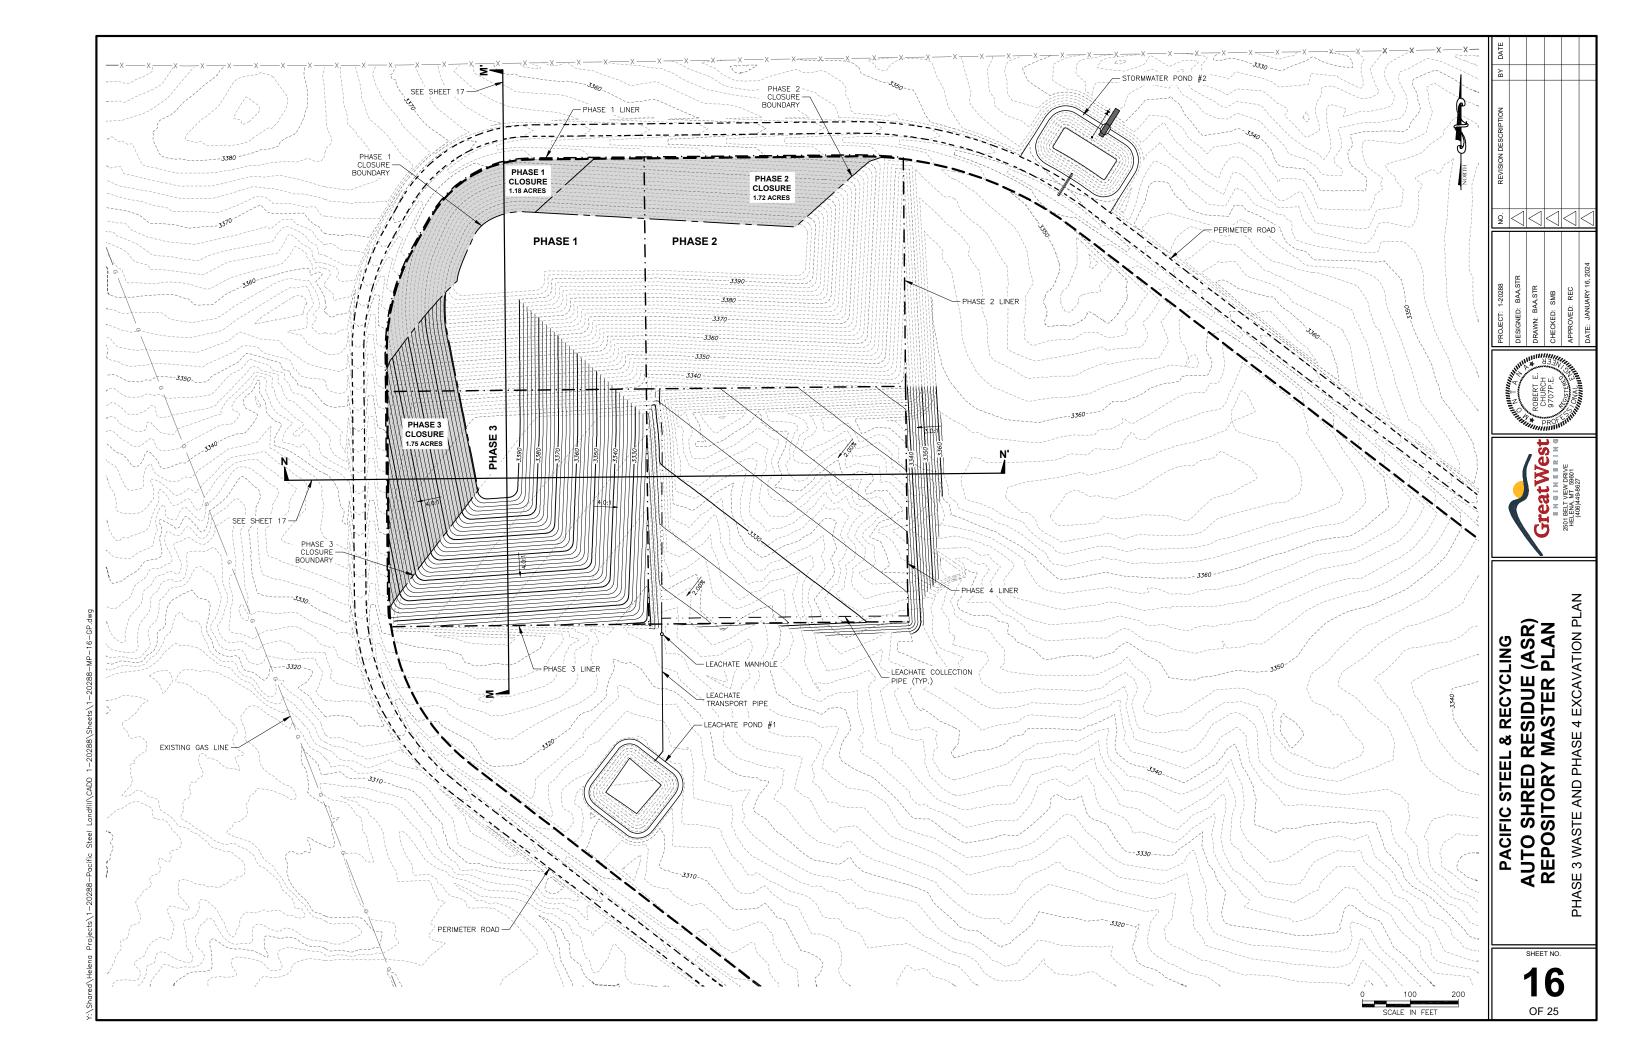

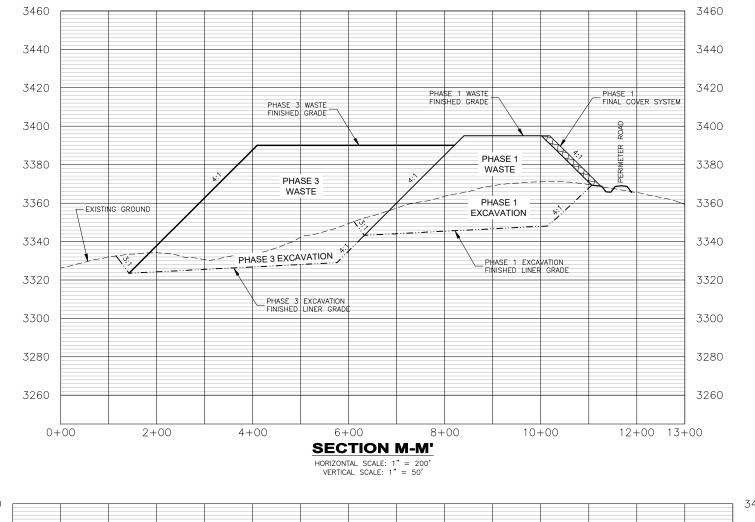


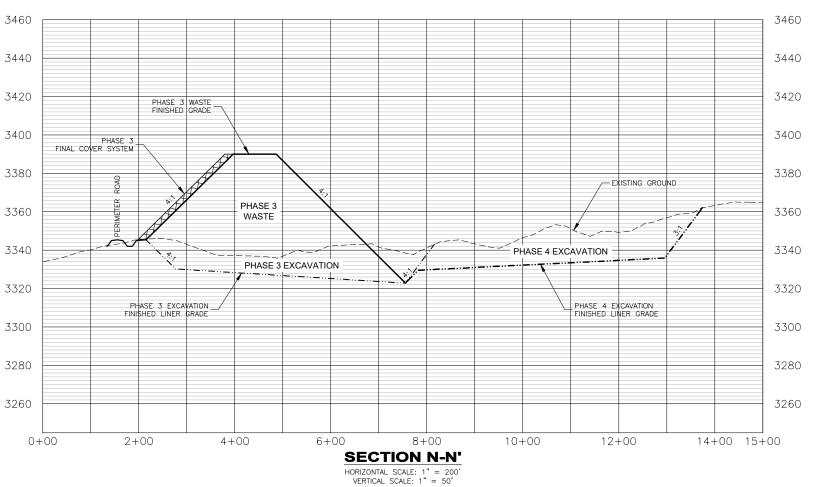





PACIFIC STEEL & RECYCLING AUTO SHRED RESIDUE (ASR) REPOSITORY MASTER PLAN CROSS SECTIONS

SHEET NO.

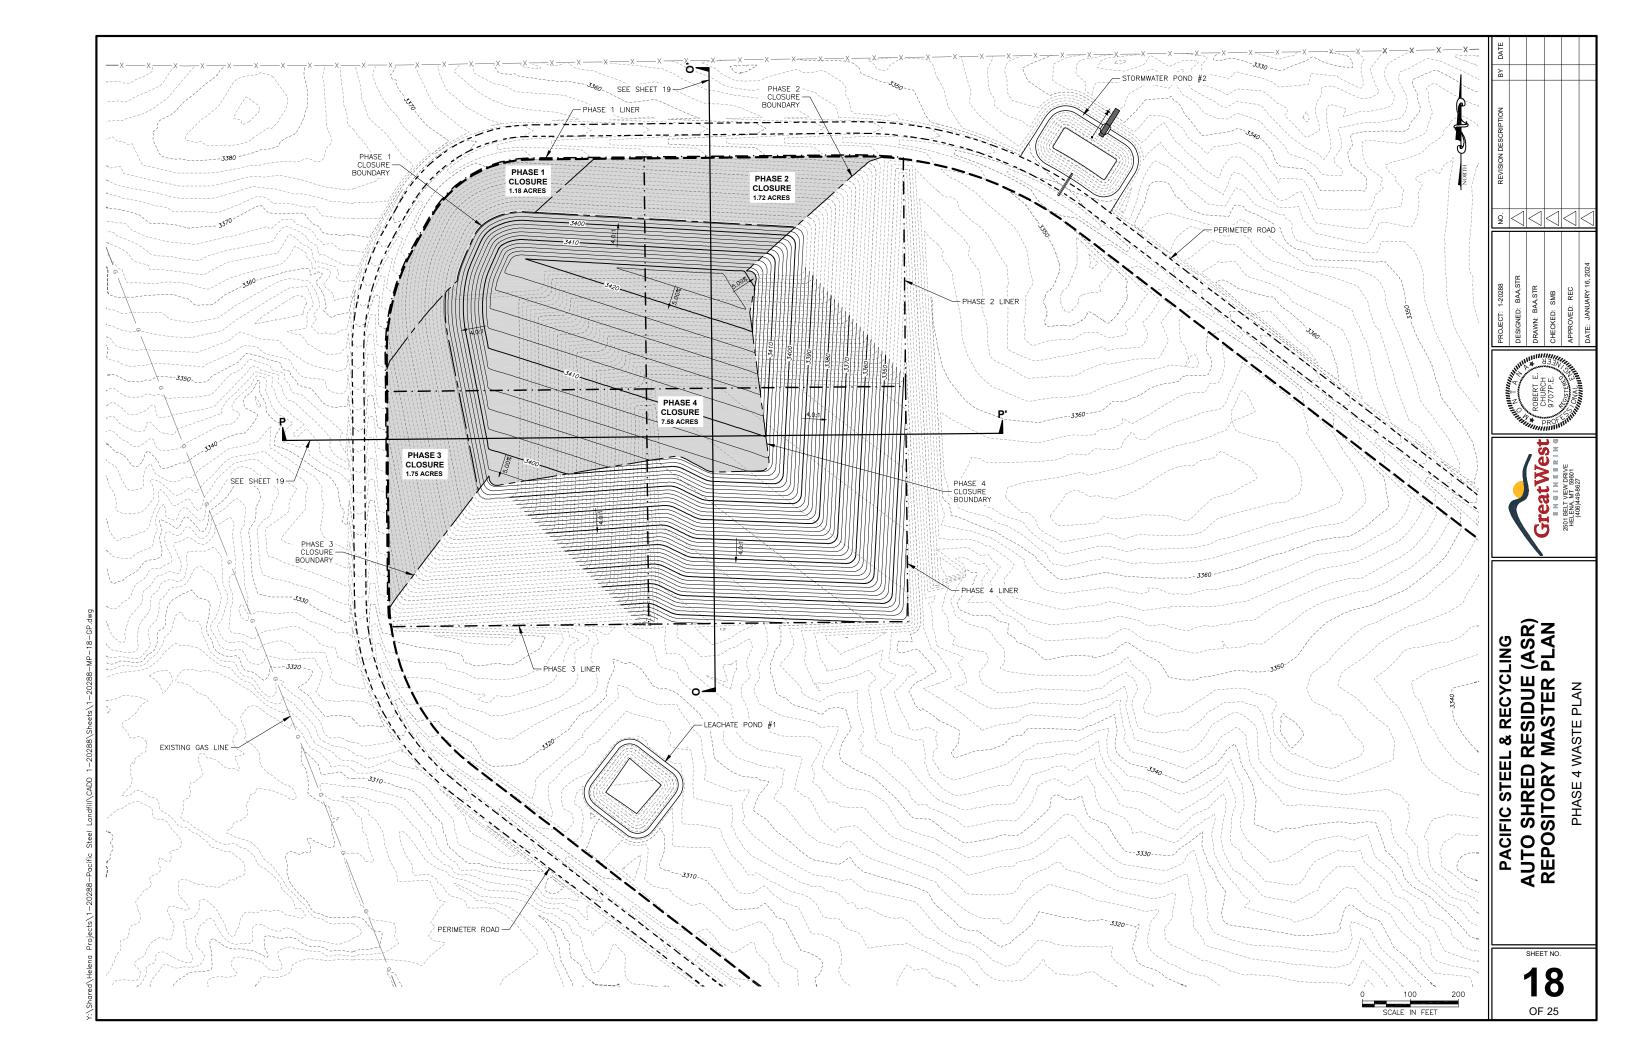

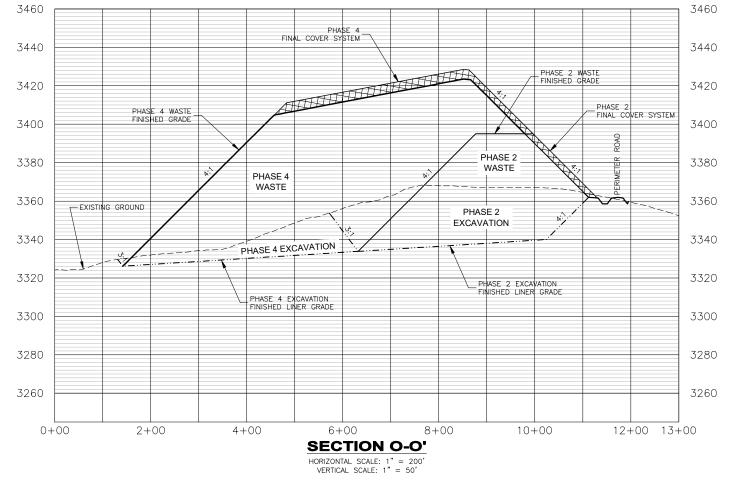

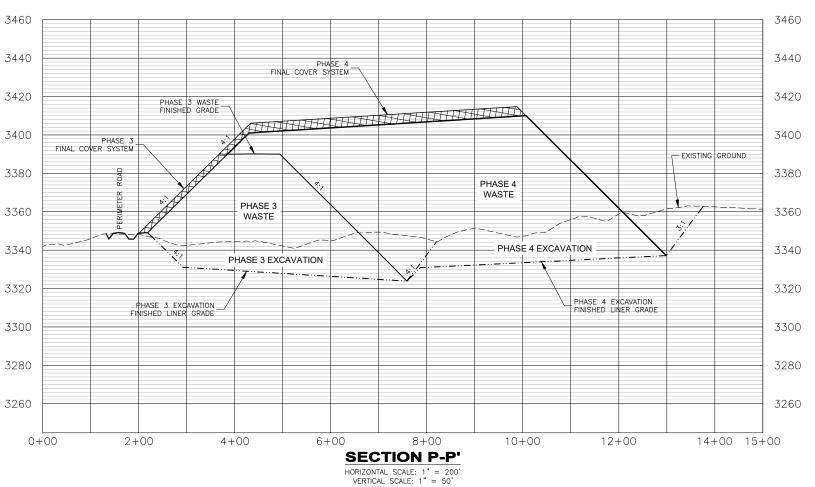




PACIFIC STEEL & RECYCLING AUTO SHRED RESIDUE (ASR) REPOSITORY MASTER PLAN

CROSS SECTIONS

SHEET NO. 19 OF 25

# GRAVEL ROAD TYPICAL SECTION NOT TO SCALE

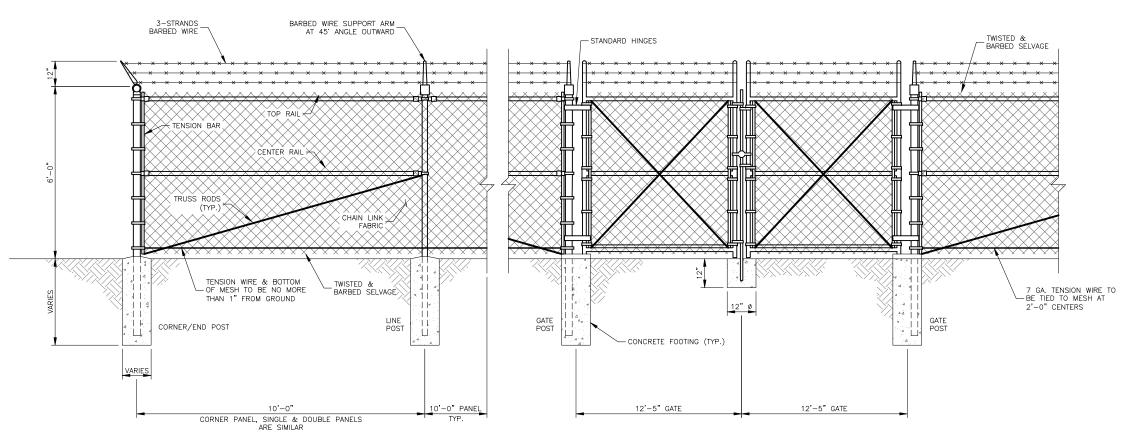

- FENCE MATERIALS:

  1. FABRIC TO BE 9 GAUGE 2" MESH
- 2. POST SPACING NOT TO EXCEED 10'-0"
  3. POSTS, RAILS, BRACING, AND CONCRETE WILL BE SIZED BY FENCE MANUFACTURER BASED ON FENCE HEIGHT

- NOTES:

  1. PULL POST BRACING SHALL BE SAME AS CORNER BRACING
  2. A DROP BAR LOCKING DEVICE IS REQUIRED FOR DOUBLE GATE. THE DROP BAR SHALL
  BE ABLE TO BE INSERTED INTO THE CONCRETE BLOCK AT LEAST 6".

  3. AT LEAST ONE POST WILL BE EXTENDED 3' INTO GROUND FOR LIGHTNING PROTECTION
  4. CHAIN LINK MESH TO BE TIED TO TOP & CENTER RAILS AT 2'-O" CENTERS.


  5. GATE CHAIN LINK FABRIC SHALL MATCH FENCE CHAIN LINK FABRIC.


  6. GATE FRAMES SHALL BE WELDED & BRACES FURNISHED AS REQUIRED.

2 PERIMETER FENCE DETAIL
20 NOT TO SCALE

PACIFIC STEEL & RECYCLING AUTO SHRED RESIDUE (ASR) REPOSITORY MASTER PLAN


SHEET NO. 20

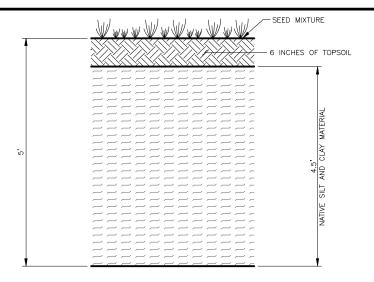

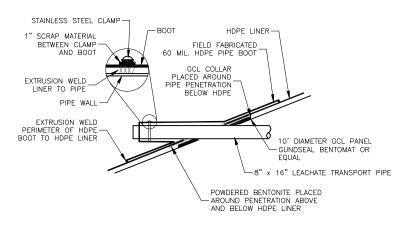

# 1 LANDFILL FINAL COVER SYSTEM 21 NOT TO SCALE

# 2 LINER PENETRATION DETAIL 21 NOT TO SCALE

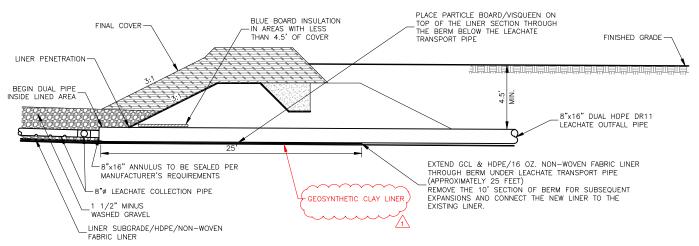

HDPE/16 OZ. FABRIC

HDPE/16 OZ. FABRIC

MAKE LINER CONTINUOUS
THROUGH BERM EXTRUSION
WELD ADJACENT PANELS

DOUBLE WALL LEACHATE
TRANSPORT PIPE

PLACE PARTICLE BOARD/VISQUEEN
ON TOP OF THE LINER SECTION
THROUGH THE BERM BELOW THE
LEACHATE TRANSPORT PIPE

FINAL COVER-

3 LEACHATE COLLECTION REMOVAL SYSTEM DURING PHASED EXPANSIONS

4 LEACHATE TRANSPORT PIPE SECTION
21 NOT TO SCALE

GreatWest
ENGINERING
ZSOIBELVEW DRIVE
HEENAMT 59601
(406)449-8627


PACIFIC STEEL & RECYCLING AUTO SHRED RESIDUE (ASR) REPOSITORY MASTER PLAN

SHEET NO.

21

LINER TERMINATION AND TEMPORARY RUN-ON CONTROL DITCH SECTION

NOT TO SCALE

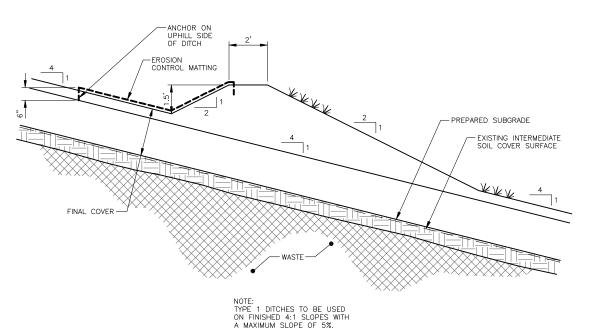


2 TYPE 1 DITCH SECTION-SIDE SLOPE DITCHES ON FINAL COVER
NOT TO SCALE

shared/Helena Projects/1—20288—Pacific Steel Landfill/CADD 1—20288/Sheets/1—20288—MP—2;







PACIFIC STEEL & RECYCLING AUTO SHRED RESIDUE (ASR) REPOSITORY MASTER PLAN

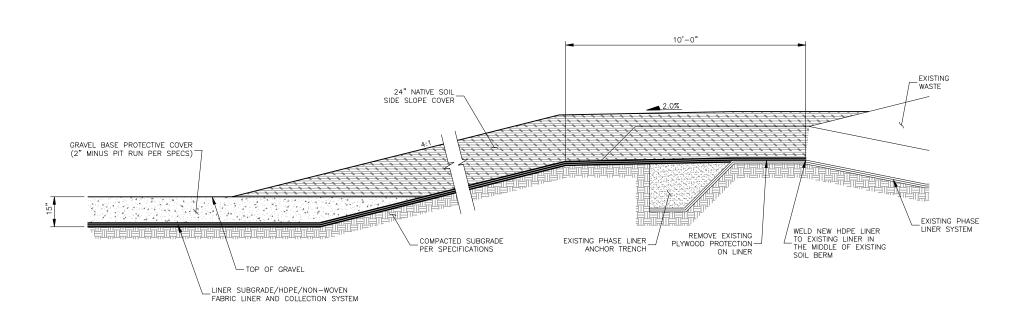


## **TYPICAL LINER TIE-IN SECTION**

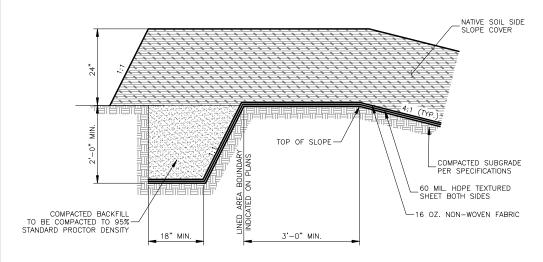

**TYPICAL ANCHOR TRENCH DETAIL** 

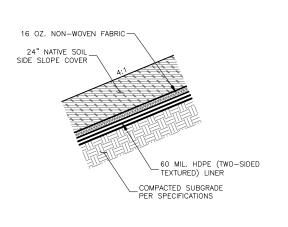

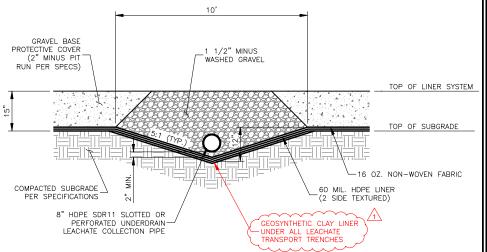

**TYPICAL SIDE SLOPE LINER DETAIL** 


TYPICAL BASE LINER/LEACHATE COLLECTION LATERAL CROSS SECTION

**23** 

9 41414

PACIFIC STEEL & RECYCLING AUTO SHRED RESIDUE (ASR) REPOSITORY MASTER PLAN DETAILS


SHEET NO.

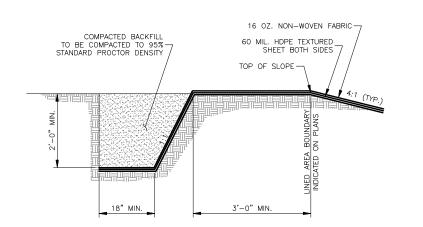

**TYPICAL LINER ANCHOR TRENCH DETAIL** 

12"x15' \_PROTECTIVE STEEL PIPE CLEANOUT 1 1/2" MINUS\_ WASHED GRAVEL 24" NATIVE SOIL SIDE SLOPE COVER 8" HDPE SDR 11 SLOTTED OR PERFORATED UNDERDRAIN-LEACHATE COLLECTION PIPE ANCHOR TRENCH: SOLID HDPE SDR11 PIPE HINGED LOCKING CAP (LOCKING CAP TO CONSIST OF HINGED PLATE STEEL CAP EQUIPPED WITH PLATE HASP. HASP WILL LOCK WITH HASP WELDED TO PIPE) COMPACTED SUBGRADE PER SPECIFICATIONS \_LINER SUBGRADE/HDPE/NON-WOVEN
FABRIC LINER AND COLLECTION SYSTEM


**LEACHATE CLEANOUT SECTION** 

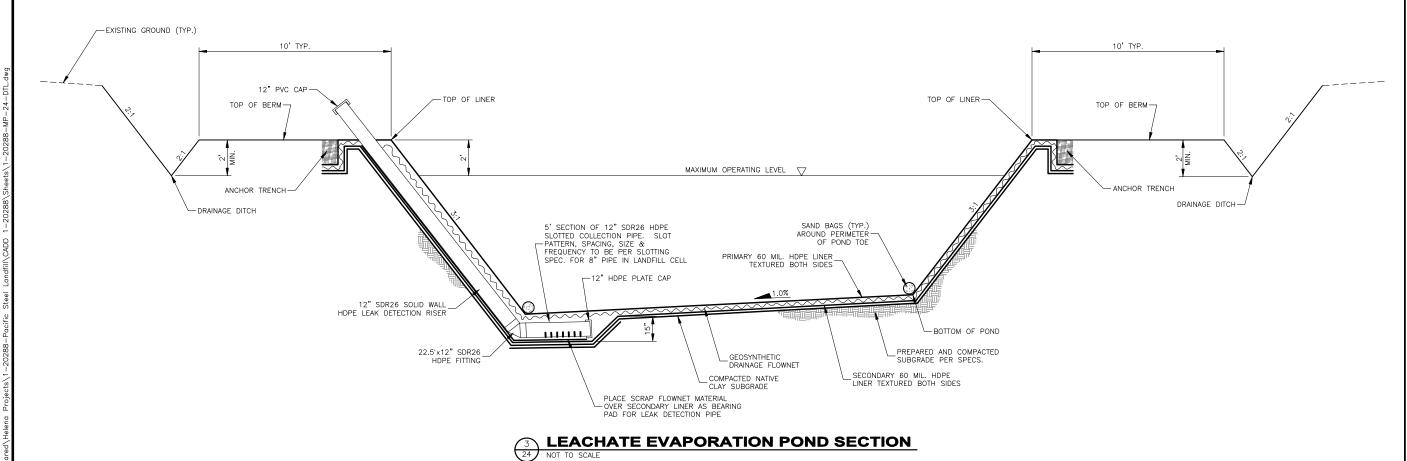




PACIFIC STEEL & RECYCLING AUTO SHRED RESIDUE (ASR) REPOSITORY MASTER PLAN

SHEET NO. 24

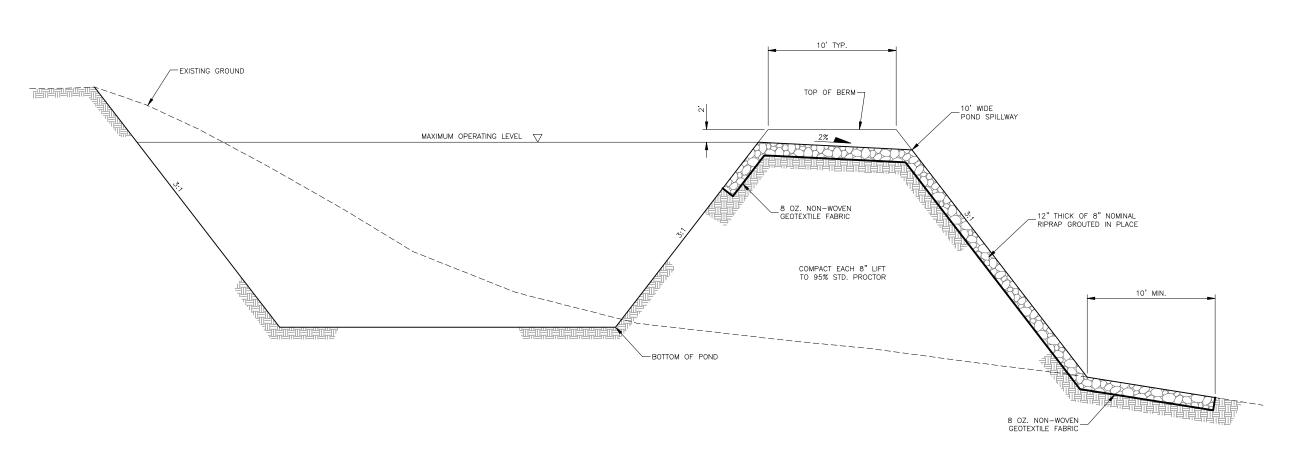


STORMWATER DETENTION POND SECTION


NOT TO SCALE

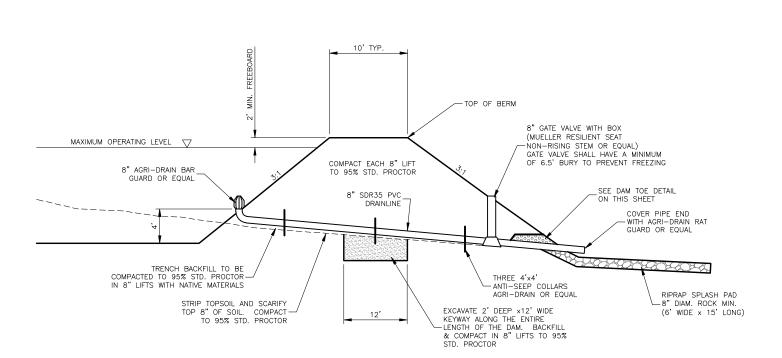

### STORMWATER DETENTION POND DRAINLINE DETAIL

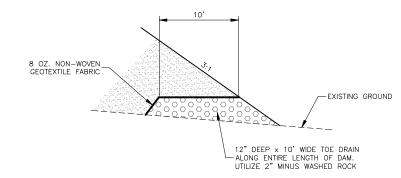

### DAM TOE DETAIL

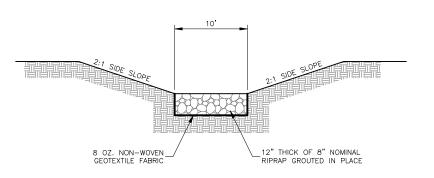

### SPILLWAY DETAIL

NOT TO SCALE


BERT E. HURCH
HURCH
CHECKED: SMB
CAPROVED: REC
APPROVED: REC
ADJAIL TO THE JANUARY 16, 2024



Great Wes E N G I N E I

PACIFIC STEEL & RECYCLING AUTO SHRED RESIDUE (ASR) REPOSITORY MASTER PLAN

> 25 0F 25

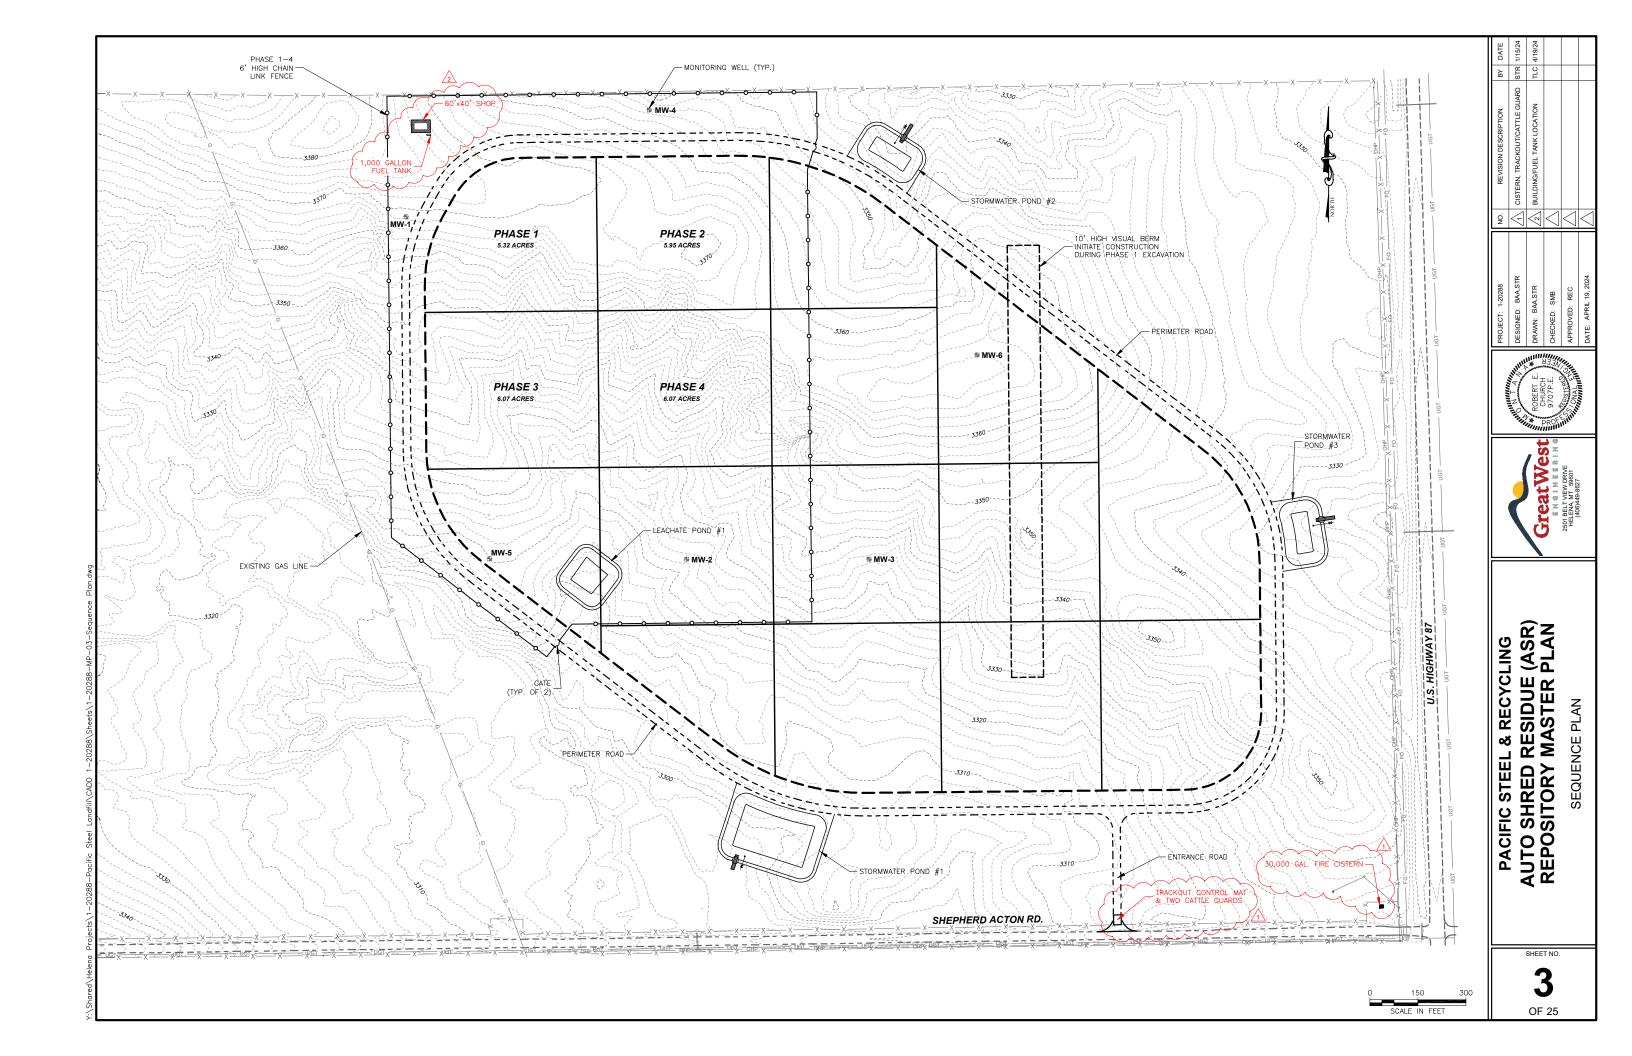

# MONTANA SAGE GROUSE HABITAT CONSERVATION PROGRAM



GREG GIANFORTE, GOVERNOR

1539 ELEVENTH AVENUE

# STATE OF MONTANA -

PHONE: (406) 444-0554 FAX: (406) 444-6721

PO BOX 201601 HELENA, MONTANA 59620-1601

Project No. 4969 Governor's Executive Orders 12-2015 and 21-2015 Pacific Steel Auto Shred Residue Repository

Travis Craig Great West Engineering 2501 Belt View Dr. Helena, MT 59601

May 8, 2024

Dear Mr. Craig,

The Montana Sage Grouse Habitat Conservation Program received a request for consultation and review of your project or proposed activity on October 7, 2022. Additional information necessary to complete a Program review was received on November 14, 2023. The original Program Consultation Letter Package was issued on November 16, 2023. Here, Pacific Steel and Recycling is requesting to start project activities on June 17, 2024 instead of August 1, 2024. Based on the information provided, all or a portion of this project is located within General Habitat for sage grouse. The Bureau of Land Management (BLM) classifies this area as a General Habitat Management Area (GHMA).

Executive Orders 12-2015 and 21-2015 set forth Montana's Sage Grouse Conservation Strategy. Montana's goal is to maintain viable sage grouse populations and conserve habitat so that Montana maintains flexibility to manage our own lands, our wildlife, and our economy and to ensure that a listing under the federal Endangered Species Act is not warranted in the future.

The Program has completed its review, including:

#### **Project Description:**

Project Type: Infrastructure - Industrial/Commercial

Project Disturbance: 90.13 Acre Landfill; 0.62 Acre Leachate Pond; Three Stormwater

Ponds Totaling 3.03 Acres; 368.48-Foot-Long Access Road; 1.53-Mile-Long Perimeter Road; 0.10 Acre Building; 0.32-Mile

Long Buried Power Line

**Construction Timeframe:** June 17, 2024 to December 31, 2024, Short Term (1-5 Years)

**Operations Timeframe:** January 1, 2025 to Permanent (>25 Years)





#### **Project Location:**

**Legal:** Township 2 North, Range 26 East, Section 3

County: Yellowstone Ownership: Private

#### Project Description and Executive Orders 12-2015 and 21-2015 Consistency:

The Pacific Steel Auto Shred Residue Repository Project proposes to construct an automobile shred residue repository facility in designated General Habitat for sage grouse.

Pacific Steel and Recycling proposes to build an automobile landfill and associated infrastructure approximately six and a half miles northeast of Billings, Montana in Yellowstone County. See Figure 1 in the enclosed Mitigation Plan (Pacific Steel Auto Shred Residue Repository Project Location Map).

The Pacific Steel Auto Shred Residue Repository Project will include a 0.6 leachate pond within a 90-acre landfill, and three storm water ponds totaling 3.03 acres. A new access road will provide access to the landfill from Shepherd Acton Road and a 24-foot-wide road will provide access to the perimeter of the landfill and the three stormwater ponds. A maintenance building and buried power line will also be installed to support the facility.

The equipment necessary for the construction of this Project includes a scraper, dozer, excavator, and haul truck.

The Project proposes to disturb the area in phases. Once a new phase is opened, the previous phase will be closed and reclaimed. Phase closure will include the capping of the waste with a Department of Environmental Quality (DEQ-approved final closure cap. Closed caps will be reseeded with a native seed mixture.

Based on the information you provided, your Project is not within two miles of an active sage grouse lek. See Figure 2 in the enclosed Mitigation Plan (Pacific Steel Auto Shred Residue Repository Lek Location Map).

#### Mitigation:

For the Pacific Steel Auto Shred Residue Repository Project, the Program calculated mitigation for the 90.13-acre landfill, 368.48-foot-long access road, 1.53-mile-long perimeter road, 0.62 acre leachate pond, three stormwater ponds totaling 3.03 acres, one 0.097-acre building, and 0.32-mile-long buried power line.

Estimated Functional Acres Lost Over the Life of the Project and Total Debit Obligation

The Program has calculated functional acres lost within the project area using the Habitat Quantification Tool (HQT) October 2018 v1.0, and Policy Guidance Document October 2018 v1.0. The HQT was calculated on October 20, 2022, with one year of construction, 99 years of





operations, and the default 75 years of reclamation. The results for this Project are described as follows.

HQT Functional Acres Lost: 7,301.83 Reserve Account (20%): 1,460.37 Advance Payment (10%): 730.18 Total Debit Obligation: 9,492.38

The direct footprint, indirect impact area, and applicable policy multipliers for this Project will result in a total of 9,492.38 debits. See Figure 3 in the enclosed Mitigation Plan (Pacific Steel Auto Shred Residue Repository Project HQT Basemap v1.0 Map and Operation Phase Map). Pacific Steel and Recycling provided a Mitigation Plan outlining Project specific avoidance, minimization, reclamation and compensatory mitigation to address Project impacts. Pacific Steel and Recycling chose to fulfill the mitigation obligation by making a contribution to the Stewardship Account.

#### Mitigation Plan

The Mitigation Plan describes avoidance, minimization, reclamation, and compensatory mitigation measures Pacific Steel and Recycling will implement to address and mitigate for unavoidable impacts from Executive Order 12-2015. Pacific Steel and Recycling has voluntarily committed to this Mitigation Plan (including compensatory mitigation).

#### The Mitigation Plan:

- describes the Project and summarizes activities that would occur within it;
- describes project mitigation in accordance with Executive Orders 12-2015 and 21-2015;
- summarizes potential impacts to sage grouse and sage grouse habitats;
- describes where the project adheres to the mitigation hierarchy through avoidance, minimization, reclamation; and
- explains Pacific Steel Recycling will make a contribution to the Stewardship Account to fulfill the mitigation debit obligation.

Pacific Steel and Recycling chose to fulfill the mitigation obligation by making a contribution to the Stewardship Account. Instructions for making a contribution to the Stewardship Account are enclosed and require your signature. The Payment Cover Memo is intended to assist with the Program's recordkeeping. The Stewardship Account Donation Form includes instructions for wire transfer or check payments, found at the bottom of the form. Let us know what form of payment you would like to use when you return the signed forms. Payment should be made after you obtain your necessary permits but **before** initiating the project activity.

#### **Program Recommendations:**

The following stipulations are taken from Montana Executive Order 12-2015. These stipulations are designed to maintain existing levels of suitable sage grouse habitat by managing uses and activities in sage grouse habitat to ensure the maintenance of sage grouse abundance and





distribution in Montana. Development should be designed and managed to maintain populations and sage grouse habitats.

- Reclamation should re-establish native grasses, forbs, and/or shrubs during interim and final reclamation. The goal of reclamation is to achieve cover, species composition, and life form diversity commensurate with the surrounding plant community or desired ecological condition to the benefit of sage grouse and replace or enhance sage grouse habitat to the degree that environmental conditions allow.
- Weed management is required within General Habitat for sage grouse. Reclamation of disturbed areas must include control of noxious weeds and invasive plant species, including cheatgrass (*Bromus tectorum*) and Japanese brome (*Bromus japonicas*).
- Implementation of the Mitigation Plan is binding, and the signed Program letter and Mitigation Plan package shall be attached to any permit the State issues. It is the Program's and MSGOT's expectation that the Mitigation Plan will be an integral part of any associated project permits.

Subject to the stipulations described above and voluntarily agreed to by Pacific Steel and Recycling in the enclosed Mitigation Plan, your activities are consistent with the Montana Sage Grouse Conservation Strategy. Your proposed project or activity may need to obtain additional permits or authorization from other Montana state agencies or possibly federal agencies. They are very likely to request a copy of this consultation letter, so please retain it for your records.

Please be aware that if the location or boundaries of your proposed project or activity change in the future, or if new activities are proposed within one of the designated sage grouse habitat areas, please visit <a href="https://sagegrouse.mt.gov/">https://sagegrouse.mt.gov/</a> and submit the new information.

Thanks for your interest in sage grouse and your commitment to taking the steps necessary to ensure Montana's Sage Grouse Conservation Strategy is successful.

Sincerely,

Therese Hartman

Montana Sage Grouse Habitat Conservation Program Manager





#### **Enclosures:**

- 1. Pacific Steel Auto Shred Residue Repository Mitigation Plan
- 2. Stewardship Account Donation Instructions
- cc. Fred Collins
  Solid Waste Management Section Supervisor
  Montana Department of Environmental Quality
  <a href="mailto:deqswprogram@mt.gov">deqswprogram@mt.gov</a>





# Pacific Steel Auto Shred Residue Repository Project 4969

May 8, 2024

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## 1.0 Introduction and Project Description

The Pacific Steel Auto Shred Residue Repository Project proposes to construct an automobile shred residue repository facility in designated General Habitat for sage grouse.

Pacific Steel and Recycling proposes to build an automobile landfill and associated infrastructure approximately six and a half miles northeast of Billings, Montana in Yellowstone County. See Figure 1 in the enclosed Mitigation Plan (Pacific Steel Auto Shred Residue Repository Project Location Map).

The Pacific Steel Auto Shred Residue Repository Project will include a 0.6 leachate pond within a 90-acre landfill, and three storm water ponds totaling 3.03 acres. A new access road will provide access to the landfill from Shepherd Acton Road and a 24-foot-wide road will provide access to the perimeter of the landfill and the three stormwater ponds. A maintenance building and buried power line will also be installed to support the facility.

The equipment necessary for the construction of this project include a scraper, dozer, excavator, and haul truck.

The Project proposes to disturb the area in phases. Once a new phase is opened, the previous phase will be closed and reclaimed. Phase closure will include the capping of the waste with a DEQ-approved final closure cap. Closed caps will be reseeded with a native seed mixture.

#### 1.1 Vegetative Community

The proposed site is located approximately four miles northeast of Sheridan, Montana. The Montana Spatial Data Infrastructure Land Use/Land Cover database (MSDI LULC, last updated December 2017) classifies the vegetation within the direct footprint and adjacent to the Project area as Big Sagebrush Steppe Montane Sagebrush Steppe.

#### 1.2 Sage Grouse Populations Affected

The Pacific Steel Auto Shred Residue Repository Project is not within two miles of an active sage grouse lek. See Figure 2 (Pacific Steel Auto Shred Residue Repository Lek Location Map).

## 2.0 Executive Order 12-2015 Consistency Review

The Pacific Steel Auto Shred Residue Repository Project is located completely within General Habitat. Stipulations recommended in Executive Order 12-2015 (EO) are designed to maintain existing sage grouse populations and levels of suitable sage grouse habitat, and guide development activities in General Habitat in a manner that sustains sage grouse abundance and distribution in Montana.

Delineated Core Areas are important for maintaining the abundance and distribution of sage grouse across Montana. Development scenarios in General Habitat are more flexible than in Core Areas but must still be designed and managed to maintain sage grouse populations and habitats.

- 2.1 Montana EO 12-15 Stipulations That Apply to Projects in Designated Habitat The entire Pacific Steel Auto Shred Residue Repository Project is in General Habitat. Projects located in General Habitat may be subject to the following stipulations per Executive Order 12-2015.
  - **Surface Occupancy:** Within 0.25 miles of the perimeter of active sage grouse leks there will be no surface occupancy (NSO) for new activities.
  - Seasonal Use: As authorized by permitting agency or agencies, activities will be prohibited from March 15 through July 15 within 2.0 miles of an active lek where breeding, nesting, and early brood-rearing habitat is present.
  - Vegetation Removal: Will be limited to the minimum disturbance required by the project. **Noise**: New project noise levels, either individual or cumulative, should not exceed 10dBA (as measured by L50) above baseline noise at the perimeter of an active lek from 6:00 p.m. to 8:00 a.m. during the breeding season (March 1 through July 15).
- 2.2 Deviations that Apply to the Pacific Steel Auto Shred Residue Repository Project The entire Pacific Steel Auto Shred Residue Repository Project is beyond two miles of an active sage grouse lek in General Habitat. Therefore, activities associated with the Project are not expected to deviate from Executive Order 12-2015 guidance and stipulations.

#### 2.3 Adherence to Mitigation Hierarchy

The Pacific Steel Auto Shred Residue Repository Project is located within designated General Habitat for sage grouse.

#### 2.3.1 Avoidance

The Pacific Steel Auto Shred Residue Repository Project is located in General Habitat. Therefore, it does not avoid impacts to sage grouse habitat.

#### 2.3.2 Minimization

The Pacific Steel Auto Shred Residue Repository Project is outside of the two-mile buffer of any active sage grouse lek. Therefore, impacts to sage grouse are minimized through Project siting.

#### 2.3.3 Reclamation

The Project proposes to disturb the area in phases. Once a new phase is opened, the previous phase will be closed and reclaimed. Phase closure will include the capping of the waste with a Department of Environmental Quality (DEQ)-approved final closure cap. Closed caps will be reseeded with a native seed mixture.

## 3.0 Compensatory Mitigation

The Program ran the Habitat Quantification Tool (HQT) using HQT v1.0 October 2018. The HQT models direct and indirect impacts from a project, and overlays those impacts on the HQT Basemap to calculate the total amount of functional acres lost due to the Project (Table 1). The HQT was calculated on October 19, 2022. The model was calculated with a one-year construction phase, a 99-year operations phase, and the default 75 years of reclamation. See Figure 3 (Pacific Steel Auto Shred Residue Repository Project HQT Basemap v1.0 Map and Operation Phase Map). The Raw HQT Score is 7,301.83 functional acres lost.

#### 3.1.1 Habitat Quantification Tool Results

Table 1. Raw HQT Score Applied to the Pacific Steel Auto Shred Residue Repository Project.

Raw HQT Score - Preliminary Results			
Habitat Type	Project Phase	Impact Area	Raw HQT Score
	Construction	Direct Impact	14.27
		Indirect Impact	83.72
Camanal	Operations	Direct Impact	1,416.45
General Habitat		Indirect Impact	5,221.63
Tiabitat	Reclamation	Direct Impact Only	565.70
	All Phases	Direct Impact	1,996.48
		Indirect Impact	5,305.35
Total Raw HQT Score			7,301.83

#### 3.1.2 Application of Policy Modifiers

The Mitigation System Policy Guidance v1.0 October 2018 document was applied to the Pacific Steel Auto Shred Residue Repository Project. The Policy outlines specific multipliers to incentivize consistency with the EO stipulations. Multipliers also ensure that mitigation is timely and effective throughout the life of the project.

<u>Risk and The Reserve Account Contribution</u> is accounted for through the Reserve Account multiplier. It is mandatory. Twenty percent of the Raw HQT Score is calculated and added to the Raw HQT Score. This accounts for the fact that impacts are estimated. The Reserve Account also functions as a shared insurance pool so that credits may be replaced if credit sites do not produce as many credits as predicted or credits are lost due to an Act of God, such as a wildfire.

<u>Advance Payment</u> of 10% is applied to the total Raw HQT Score for direct and indirect impacts for the life of the project where the proponent will not undertake permittee responsible mitigation and would make a contribution to the Stewardship Account.

<u>Federal Net Gain</u> of 10% is applied when the project involves a federal nexus. Calculations are based on only the portion of the project having a federal nexus.

<u>Site-Specific Impacts</u> are addressed through a multiplier of 10% for a Core Area, or 5% for General Habitat for each aspect of a proposed project that is not consistent with the EO 12-2015 stipulations during either construction or operations phase of a project.

Programmatic Multipliers for all phases of the Pacific Steel Auto Shred Residue Repository Project are shown on Table 2. The Raw HQT Score (7,301.83) was multiplied by 20% to calculate Reserve Account debits of 1,460.37. A 10% Advance Payment of 730.18 debits is added because here the State assumes responsibility to find offsets in that Pacific Steel and Recycling opted to make a contribution instead of undertaking a permittee responsible mitigation project. The Project is fully consistent with EO 12-2015 site specific stipulations, therefore, no site-specific multipliers were added to the HQT score. The Policy Multipliers resulted in 2,190.55 debits.

Table 2. Policy Multipliers Applied to the Pacific Steel Auto Shred Residue Repository Project.

Policy Multiplier			
Policy Application (conversion from Functional Acres Lost to Debits)			
Multiplier Type	Specific Multiplier	General Habitat	Debits
Programmatic Multipliers	Reserve Account (20%)	1	1,460.37
(Construction Operation and Reclamation)	Adv. Payment (10%)	1	730.18
Federal Portion Only	Net Gain	0	0
<b>Total Policy Multiplier Debits</b>	2,190.55		

#### 3.1.3 Total Mitigation Debit Obligation

The total mitigation debit obligation is based on the total Raw HQT Score (7,301.83) plus the total Policy Multiplier debits (2,190.38), applicable to the Pacific Steel Auto Shred Residue Repository Project (Table 3). The final total mitigation debit obligation for the project is 9,492.38 debits.

Table 3. Total Debits Applied to the Pacific Steel Auto Shred Residue Repository Project.

Total Debits			
Total Raw HQT Score	7,301.83		
Total Policy Multiplier Debits	2,190.55		
Total Debit Obligation	9,492.38		

To fulfill the 9,492.38-mitigation debit obligation, Pacific Steel and Recycling elected to make a contribution to the Stewardship Account. Credits obtained through the Stewardship Account are currently \$13 per debit. The total mitigation debit obligation of 9,492.38 is multiplied by \$13. The total is then discounted by 3% over the life of the project using a discounting method. The final total for the Pacific Steel Auto Shred Residue Repository Project is \$37,664.54 (Table 4).

Table 4. Total When Making Contribution to Stewardship Account.

Total		
Total Debit Obligation	9,492.38	
Contribution After Applying Credit Discount Method	\$37,664.54	

# 4.0 Mechanism Selected to Fulfill the Compensatory Mitigation Obligation

Pacific Steel and Recycling has committed to a compensatory mitigation obligation of \$37,664.54 to be deposited in the Montana Sage Grouse Stewardship Fund (see MCA 87-5-909((1)(a)(ii)). Funds would be deposited after confirmation of approval for permits but before construction begins.

The MSGOT and Program would disburse these funds through the Stewardship Account granting process to conserve habitat and sage-grouse populations through offsite mitigation. Any benefit of onsite


mitigation would be negated until such activities were completed and disturbed lands fully reclaimed. The Pacific Steel Auto Shred Residue Repository Project is in the Central Service Area. MSGOT will be encouraged to apply these funds to mitigation within the Project's same Service Area so that greater conservation benefits to sage-grouse can be secured offsite.

Counties

Exempt Community Boundaries
Proposed Disturbances EO-Core Area
EO-Connectivity Area
EO-General Habitat
Not In EO Area Figure 1- Pacific Steel Auto Shred Residue Repository Project Location Map

Lek No Surface Occupancy Areas EO-Core Area
EO-Connectivity Area
EO-General Habitat
Not In EO Area
Counties Proposed Disturbances Lek 2-Mile Buffer Figure 2- Pacific Steel Auto Shred Residue Repository Project Lek Location Map

Figure 3: Pacific Steel Auto Shred Residue Repository Project HQT Basemap v1.0 Map and Operation Phase Map

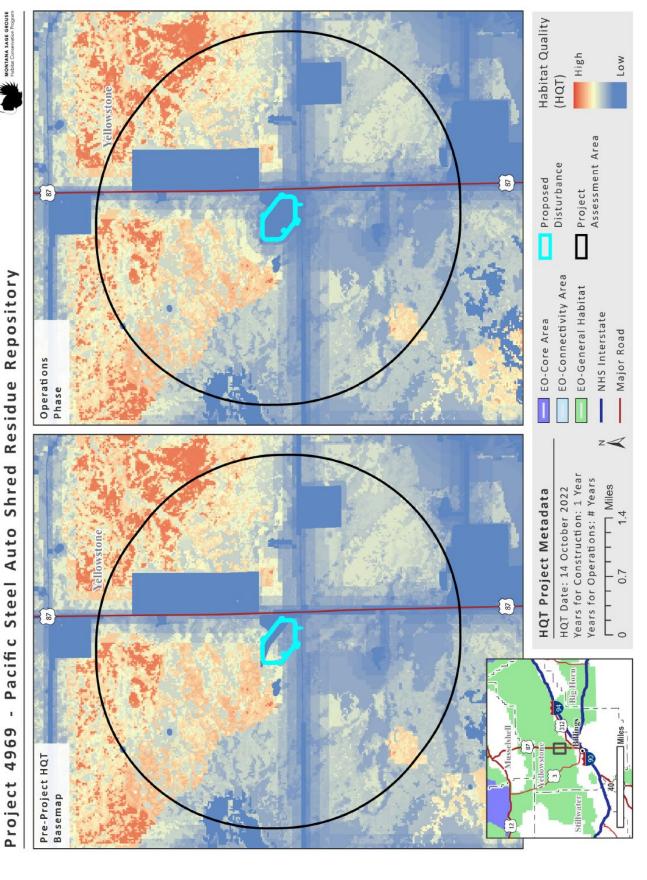



### **Instructions for Contribution to the Stewardship Account**

- 1. The project developer/permit holder or applicant should review the two attached forms.
  - The Payment Acknowledgment Form allows DNRC fiscal staff and the Program to track of the transaction.
  - The Stewardship Account Contribution Form recaps your mitigation approach and serves as an invoice for payment. You are welcome to forward this form to your accounting office or bookkeeper.
- 2. The forms should be signed by the developer, authorized permit applicant or permit holder and returned to the Program prior to making a payment.

The signed forms may be scanned and emailed to the Program reviewer:

Emoran@mt.gov

or mailed to:

Montana Sage Grouse Habitat Conservation Program P.O. Box 201601 Helena, MT 59620

3. Payment should be made **after** you obtain your necessary permits but **before** initiating the project activity.

Instructions for wire transfer or check payments are found at the bottom of the Stewardship Account Contribution Form.

4. The Program will sign the forms and will save the completed Payment Acknowledgment Form and Stewardship Account Donation Form as a package within your online project file, if you need a copy of the documents in the future.

# STATE OF MONTANA SAGE GROUSE STEWARDSHIP ACCOUNT CONTRIBUTION FORM



Developed News		Data	
Developer's Name		Date	
Address			
City	StateZip	_	
Phone			
Description of Durance of Funds			A m a v m t
Description of Purpose of Funds			Amount
Developer's Signature:			
Date:			
COMMENTS FOR SPECIAL INSTRUCTION:	Wire Instructions:		
Funds can be remitted by check or wire.	Name on Account: State of Mont	ana	
,	Routing # 092900383 (last digit is		
Check Payments:	Checking Account # 1560412002		
Make checks payable to:	Bank: US Bank NA MT		
DNRC	US Bank Contract: Kimberly Spir	off at 406-447-5	5251
Re: Sage Grouse Stewardship	Please include on wire info:		
P.O. Box 201601	DNRC 57060, Sage Grouse Stev	vardship	
1539 11th Avenue			
Helena, MT 59601			
Sage Grouse Contact:			
https://sagegrouse.mt.gov/			

#### **Payment Acknowledgment** APPROVED / DATE FOR DNRC AND SAGE GROUSE PROGRAM USE ONLY DeveloperName(Payor): MSGOT: ProjectName: SG Program Manager: ProjectIDNo: CARDD Administrator: \_\_\_\_ Total Number of Debits: Sage Grouse Service Area of Project: Majorand Minor Version of the HQTTechnical Manual: MONTANA SAGE GROUSE Habitat Conservation Program Majorand Minor Version of the Policy Guidance: Amount of Deposit: Date of Wire Transfer or Check Deposit: Multiple Payments Expected: Yes No If Yes, date anticipated: Purchasing Stewardship Account Credits: Yes No If Yes Grant Project Name: Contribution Equivalent to Average Cost of Credits: No If Yes, Average Cost of Credit: Yes Donation for Purposes Other than Mitigation: Yes No Purpose: Speed Chart:R2310 Fund Name: Sage Grouse Stewardship Account (Payee) Fund No. 02318 Org. No: 13 Taken together, Executive Orders 12-2015 and 21-2015 and the 2015 Greater Sage Grouse Stewardship Act (Act) set forth that Montana will observe the mitigation hierarchy and that compensatory mitigation is consistent with the purpose of incentivizing voluntary conservation measures for sage grouse habitat and populations. MCA §§ 87-5-902, 87-5-911(1)(a)-(b), (2), and (3). The number of debits attributed to a development project, and ultimately the final mitigation obligation is determined by applying the Habitat Quantification Tool and accompanying policy guidance, and as approved by the Montana Sage Grouse Oversight Team. MCA §§ 87-5-903(5), 87-5-903(9), 87-5-903(10), 87-5-905(1)(g), 87-5-911(1)-(3). Once the amount of compensatory mitigation is determined and approved, developers select their own method for offsetting debits. The Act provides for many different methods, and developers can use more than one method. MCA § 87-5-910(1)(b). Among the available methods, the Act provides that developers can purchase an equal number of credits from the available credits tracked by the Montana Sage Grouse Oversight Team or, if sufficient conservation credits are unavailable for purchase, making a financial contribution to the Sage Grouse Stewardship Account established in MCA § 87-5-909. MCA §§ 87-5-903(4), 87-5-909, 87-5-911(1)(b)(i)-(ii). This payment to the Sage Grouse Stewardship Account is made by to provide compensatory mitigation for the debits of the project in designated sage grouse habitat pursuant to MCA §§ 87-5-911(1)-(3). The purpose of the funds is to mitigate and offset impacts to sage grouse populations and habitats resulting from the Project. Additional details can be found in the approved mitigation plan and donation form.

The Montana Sage Grouse Oversight Team will approve expenditures of funds deposited to the Sage Grouse Stewardship Account consistent with the approved mitigation plan, the Greater Sage Grouse Stewardship Act, and applicable administrative rules.

	By:
Date	Developer or Authorized Representative (Payor)
	By:
Date	Sage Grouse Habitat Conservation Program (Payee)
	By:
Date	Department of Natural Resources & Conservation (Pave



### Instructions for Contribution to the Stewardship Account

- 1. The project developer/permit holder or applicant should review the two attached forms.
  - The Payment Acknowledgment Form allows DNRC fiscal staff and the Program to track of the transaction.
  - The Stewardship Account Contribution Form recaps your mitigation approach and serves as an invoice for payment. You are welcome to forward this form to your accounting office or bookkeeper.
- 2. The forms should be signed by the developer, authorized permit applicant or permit holder and returned to the Program prior to making a payment.

The signed forms may be scanned and emailed to the Program reviewer:

Emoran@mt.gov

or mailed to:

Montana Sage Grouse Habitat Conservation Program P.O. Box 201601 Helena, MT 59620

3. Payment should be made after you obtain your necessary permits but **before** initiating the project activity.

Instructions for wire transfer or check payments are found at the bottom of the Stewardship Account Contribution Form.

4. The Program will sign the forms and will save the completed Payment Acknowledgment Form and Stewardship Account Donation Form as a package within your online project file, if you need a copy of the documents in the future.

#### **Payment Acknowledgment** APPROVED / DATE FOR DNRC AND SAGE GROUSE PROGRAM USE ONLY DeveloperName(Payor): Pacific Steel and Recycling MSGOT: ProjectName: Pacific Steel Auto Shred Residue Repository SG Program Manager: ProjectIDNo: 4969 CARDD Administrator: \_ Total Number of Debits: 9.492.38 Sage Grouse Service Area of Project: Central Majorand Minor Version of the HQTTechnical Manual: October 2018 v1.0 MONTANA SAGE GROUSE Majorand Minor Version of the Policy Guidance: October 2018 v1.0 Amount of Deposit: \$37,664.54 Date of Wire Transfer or Check Deposit: Multiple Payments Expected: Yes ✓ No If Yes, date anticipated: Contribution Equivalent to Average Cost of Credits: Yes No If Yes, Average Cost of Credit: \$13.00 Donation for Purposes Other than Mitigation: Yes ✓ No Purpose:

Taken together, Executive Orders 12-2015 and 21-2015 and the 2015 Greater Sage Grouse Stewardship Act (Act) set forth that Montana will observe the mitigation hierarchy and that compensatory mitigation is consistent with the purpose of incentivizing voluntary conservation measures for sage grouse habitat and populations. MCA §§ 87-5-902, 87-5-911(1)(a)-(b), (2), and (3). The number of debits attributed to a development project, and ultimately the final mitigation obligation is determined by applying the Habitat Quantification Tool and accompanying policy guidance, and as approved by the Montana Sage Grouse Oversight Team. MCA §§ 87-5-903(5), 87-5-903(9), 87-5-903(10), 87-5-905(1)(g), 87-5-911(1)-(3).

Fund Name: Sage Grouse Stewardship Account (Payee) Fund No. 02318 Org. No: 13

Speed Chart:R2310

Once the amount of compensatory mitigation is determined and approved, developers select their own method for offsetting debits. The Act provides for many different methods, and developers can use more than one method. MCA § 87-5-910(1)(b). Among the available methods, the Act provides that developers can purchase an equal number of credits from the available credits tracked by the Montana Sage Grouse Oversight Team or, if sufficient conservation credits are unavailable for purchase, making a financial contribution to the Sage Grouse Stewardship Account established in MCA § 87-5-909. MCA §§ 87-5-903(4), 87-5-909, 87-5-911(1)(b)(i)-(ii).

This payment to the Sage Grouse Stewardship Account is made by Pacific Steel and Recycling to provide compensatory mitigation for the debits of the Pacific Steel Auto Shred Residue Repository project in designated sage grouse habitat pursuant to MCA §§ 87-5-911(1)-(3). The purpose of the funds is to mitigate and offset impacts to sage grouse populations and habitats resulting from the Project. Additional details can be found in the approved mitigation plan and donation form.

The Montana Sage Grouse Oversight Team will approve expenditures of funds deposited to the Sage Grouse Stewardship Account consistent with the approved mitigation plan, the Greater Sage Grouse Stewardship Act, and applicable administrative rules.

5/7/24	By: Kirby Farner, Corporate HSET Director
Date	Developer or Authorized Representative (Payor)
	Ву:
Date	Sage Grouse Habitat Conservation Program (Payee)
	By:
Date	Department of Natural Resources & Conservation (Payee)

# STATE OF MONTANA SAGE GROUSE STEWARDSHIP ACCOUNT CONTRIBUTION FORM



Developer's Name	Pacific Steel and Recycling		Date November 16, 202	
	5 River Dr. S			
City	Great Falls	State MT	Zip_59405	
	(406) 727-6222			
Description of Pur	pose of Funds			Amount
The Program co 2023. The Octo October 2018 v1 of debits associa Inc. selected to 1	mpleted a review o ber 2018 v1 Habita I Policy Guidance d ated with this projec	t Quantification To locuments were us t. The mitigation r obligation is to mal	Drilling Project on No ool Technical Manual sed to determine the method that Gold Exp ke a payment to the \$ 09.	syember 9, and the total number press Mines,
Date:	re: <u>K: 7</u> _ 7/24			
COMMENTS FOR S Funds can be remitted Check Payments: Make checks payale DNRC Re: Sage Grouse St P.O. Box 201601 1539 11th Avenue Helena, MT 59601 Sage Grouse Conta	ole to: ewardship	Name Routin Check Bank: US Ba Please	Instructions: on Account: State of Mong # 092900383 (last digitions) string Account # 15604120 US Bank NA MT ank Contract: Kimberly Specinclude on wire info: \$257060, Sage Grouse States	t is a check digit) 0221 piroff at 406-447-5251